

JACKSON OUTER HARBOR SPECIFICATION NO. P16015-086 6400 SOUTH COAST GUARD DRIVE CHICAGO, IL 60649

ISSUED FOR BID 08-06-2020

THE ALTERATE CONSISTS OF IMPROVEMENTS TO JACKSON OUTER HARBOR IN CHICAGO, IL. THE IMPROVEMENT INCLUDES THE CONSTRUCTION OF A NEW STEEL SHEET PILE WALL AND CONCRETE CAP. THE PARK IS NOT ON THE NATIONAL REGISTER OF HISTORIC PLACES.



LOCATION MAP



SITE MAP NO SCALE

DRAWING INDEX

COVER SHEET
GENERAL NOTES
EXISTING PLAN
PROPOSED PLAN
GRADING PLAN

6 TYPICAL SECTION & DETAILS
7 STEEL DETAILS
8 EXISTING CONDITIONS

9 BORING LOGS

AMBER M. SEIBER 081-007929

SHEETS 1 TO 9

CHICAGO
PARK
DISTRICT
541 NORTH FARBANKS
Chicogo, Illinois
60611

Sure 1200 Character 1

REVISIONS DATE

PROJ. MGR.: AMS
DESIGNER: ELN

DRAWN: ELN

CHECKED: AMS

SCALE: As Shown

DATE: 07/31/2020

SPEC. NO.: P16015-086

JOB NO.: 7416.04

SHEET INFORMATION

OUTER HARBOR

JACKSON

PARK NO./PROJECT NO.
PARK 0019
16015-086

01

GENERAL WORK SCOPE:

THIS ALTERNATE INCLUDES THE FOLLOWING WORK ITEMS TO BE PAID FOR AS LUMP SUM. ANY QUANTITIES SHOWN IN THE PLANS SHALL BE CONSIDERED AS ENGINEERING ESTIMATES ONLY. THE CONTRACTOR IS RESPONSIBLE TO DETERMINE HIS/HER OWN QUANTITIES REQUIRED FOR THE CONSTRUCTION OF THIS PROJECT.

- 1. CONSTRUCTION OF A STEEL SHEET PILE WALL AND CONCRETE CAP.
- 2. DEMOLITION OF EXISTING ROCK WALL AND PARTIAL DEMOLITION OF DEADMAN WALL.
- 3. PLACE GRANULAR MATERIAL BEHIND SHEET PILE WALL AND ERODED AREAS.
- 4. RE-GRADE AND PLACE SOD IN AREA BETWEEN SHEET PILE WALL AND LAKEFRONT TRAIL.

GENERAL NOTES:

- I. ILLINOIS DEPARTMENT OF TRANSPORTATION STANDARD SPECIFICATIONS FOR ROAD AND BRIDGE CONSTRUCTION (IDOT SSRBC) ADOPTED APRIL 1, 2016 SHALL GOVERN UNLESS OTHERWISE NOTED IN THE PLANS OR SPECIAL PROVISIONS.
- 2. BEFORE STARTING ANY EXCAVATION, THE CONTRACTOR SHALL CALL "C.U.A.N" (CHICAGO UTILITY ALERT NETWORK) AT (312)
 744-7000 FOR FIELD LOCATIONS OF BURIED ELECTRIC, TELEPHONE, AND GAS FACILITIES (48 HOUR NOTIFICATION
 REQUIRED).
- 3. THE CONTRACTOR SHALL COORDINATE CONSTRUCTION ACTIVITIES WITH UTILITY COMPANIES AND THE CITY OF CHICAGO. THE PLANS DO NOT REPRESENT A COMPLETE DEPICTION OF ALL UTILITIES THAT MAY BE IMPACTED BY THE PROPOSED WORK. THE CONTRACTOR SHALL PERFORM AN INDEPENDENT INVESTIGATION TO DETERMINE THE OWNERSHIP OF IMPACTED UTILITIES. THE CONTRACTOR SHALL COORDINATE WITH THE UTILITY OWNERS AND MAY BE REQUIRED TO PROVIDE TEMPORARY SUPPORT, ADJUST, RELOCATE, OR REMOVE UTILITIES THAT ARE IMPACTED BY THE PROPOSED IMPROVEMENT. THIS SHALL BE INCLUDED IN THE LUMP SUM BID PRICE.
- 4. EXISTING UTILITIES SHOWN ON THE PLANS ARE SHOWN FOR GENERAL ORIENTATION ONLY. LOCATIONS ARE APPROXIMATE AND MAY NOT INCLUDE ALL EXISTING UTILITIES AND UTILITY STRUCTURES.
- 5. THE CONTRACTOR SHALL NOT SCALE DIMENSIONS FROM THE CONTRACT PLANS FOR CONSTRUCTION PURPOSES.
- 6. THE CONTRACTOR SHALL EXERCISE CAUTION DURING ALL OPERATIONS TO PREVENT ANY DAMAGE TO THE EXISTING PARK ELEMENTS NOT WITHIN THE SCOPE OF THIS PROJECT. PARK ELEMENTS THAT ARE DAMAGED DURING CONSTRUCTION SHALL BE REPAIRED OR REPLACED AT THE EXPENSE OF THE CONTRACTOR.
- 7. THE CONTRACTOR SHALL REMOVE ALL CONSTRUCTION DEBRIS AND TRASH FROM THE PROJECT SITE UNLESS OTHERWISE APPROVED BY THE CHICAGO PARK DISTRICT IN WRITING.
- 8. THESE CONTRACT DOCUMENTS HAVE BEEN PREPARED BASED ON FIELD INSPECTION, EXISTING PLANS, AND OTHER INFORMATION AVAILABLE AT THE TIME. ACTUAL FIELD CONDITIONS MAY REQUIRE CHANGES TO CONSTRUCTION DETAILS. IT SHALL BE THE CONTRACTOR'S RESPONSIBILITY TO VERIFY THE PLAN DIMENSIONS AND DETAILS IN THE FIELD AND MAKE NECESSARY (APPROVED BY THE PARK DISTRICT) ADJUSTMENTS PRIOR TO CONSTRUCTION OR ORDERING OF MATERIALS.
- 9. THE CONTRACTOR MUST PROTECT AND CAREFULLY PRESERVE ALL PERMANENT SURVEY MONUMENTS, BENCHMARKS, OR PROPERTY MARKERS WHICH ARE ENCOUNTERED DURING THE COURSE OF HIS/HER WORK. IF IT IS NECESSARY TO REMOVE ANY SUCH MONUMENT OR MARKER, THE CITY OF CHICAGO COMMISSIONER MUST BE NOTIFIED PRIOR TO REMOVAL. THE CONTRACTOR MUST PROTECT AND CAREFULLY PRESERVE ALL PROPERTY MARKERS AND MONUMENTS UNTIL THE CITY OF CHICAGO COMMISSIONER, AN AUTHORIZED SURVEYOR, OR AGENT HAS WITNESSED OR OTHERWISE REFERENCED THEIR LOCATIONS. ANY SUCH MONUMENT OR MARKER WHICH HAS BEEN DISTURBED BY THE CONTRACTOR MUST BE RESET BY A REGISTERED PROFESSIONAL LAND SURVEYOR TO THE SATISFACTION OF THE COMMISSIONER AND AT NO ADDITIONAL EXPENSE.
- 10. ALL ELEVATIONS REFER TO THE CHICAGO CITY DATUM, WHICH IS 579.88 FEET ABOVE MEAN SEA LEVEL, 1935 ADJUSTMENT.

CONSTRUCTION SPECIFICATIONS

- 1. ILLINOIS DEPARTMENT OF TRANSPORTATION STANDARD SPECIFICATIONS FOR ROAD AND BRIDGE CONSTRUCTION (IDOT SSRBC) ADOPTED APRIL 1, 2016
- 2. ILLINOIS DEPARTMENT OF TRANSPORTATION SUPPLEMENTAL SPECIFICATIONS AND RECURRING SPECIAL PROVISIONS ADOPTED JANUARY 1, 2020

MATERIAL PROPERTIES

CEMENTITIOUS MATERIALS:

CAST-IN-PLACE CONCRETE SHALL BE PORTLAND CEMENT SUITABLE FOR MARINE EXPOSURE WITH A MINIMUM COMPRESSION STRENGTH (f'c) = 4000 PSI © 28 DAYS

REINFORCING STEEL:

REINFORCING STEEL SHALL BE ASTM A706 GRADE 60. EPOXY COATING SHALL BE IN ACCORDANCE WITH ASTM A775.

STEEL SHEET PILING:

SHEET PILING SHALL BE ASTM A572 GRADE 50 STEEL.

SOIL ERORSION AND SEDIMENT CONTROL NOTES

- 1. THE CONTRACTOR SHALL CONSTRUCT ALL SOIL AND SEDIMENT CONTROL MEASURES AT THE COMMENCEMENT OF THE PROJECT AND PROVIDE MAINTENANCE AND ASSURE ITS EFFECTIVENESS IN TRAPPING SEDIMENT THROUGHOUT THE TERM OF THE PROJECT.
- 2. ALL OTHER SPOILS, INCLUDING ORGANIC AND INORGANIC SOILS, VEGETATION AND DEBRIS SHALL BE REMOVED FROM THE SITE AND PROPERLY DISPOSED OF IN ACCORDANCE WITH THE STANDARD SPECIFICATIONS AND STATE REGULATIONS.
- 3. SILT FENCING SHALL BE PLACED WHERE NECESSARY TO PREVENT SEDIMENT FROM LEAVING THE SITE. THE GEOTEXTILE SILT FENCING FABRIC SHALL BE IN ACCORDANCE WITH SECTION 1080 OF THE STANDARD SPECIFICATIONS.
- 4. THE CONTRACTOR IS TO TAKE ALL NECESSARY PRECAUTIONS TO PREVENT SOIL EROSION AND RESULTING DEPOSITION FROM OCCURRING ON OR OFF THE CONSTRUCTION SITE. THE CONTRACTOR IS ADVISED THAT HE/SHE WILL BE RESPONSIBLE FOR ANY AND ALL EROSION AND RESULTING DEPOSITION OCCURRING ON OR OFF THE SITE AS THE RESULT OF CONSTRUCTION ACTIVITIES AND WILL BE DIRECTED BY THE ENGINEER TO CORRECT THE PROBLEM TO THE SATISFACTION OF THE PARK DISTRICT AND AT THE CONTRACTOR'S EXPENSE.
- 5. STREETS ADJACENT TO THE PARK SHALL BE KEPT FREE OF DIRT, MUD AN DEBRIS.

PERMITS

- 1. THE CONTRACTOR SHALL OBTAIN ALL NECESSARY PERMITS PRIOR TO COMMENCING CONSTRUCTION.
- 2. PERMITS FROM THE FOLLOWING AGENCIES WILL BE SECURED BY THE CHICAGO PARK DISTRICT:
 - US ARMY CORPS OF ENGINEERS (USACE) REGIONAL PERMIT.
 - ILLINOIS DEPARTMENT OF NATURAL RESOURCES (IDNR), OFFICE OF WATER RESOURCES
 - ILLINOIS ENVIRONMENTAL PROTECTION AGENCY (IEPA)
 - CHICAGO DEPARTMENT OF TRANSPORTATION (CDOT) HARBOR PERMIT
- 3. OFFICE OF UNDERGROUND COORDINATION (OUC) FOR THE EXISTING FACILITY PROTECTION REVIEW IS NOT REQUIRED. NO UTILITIES ARE ANTICIPATED TO BE IN CONFLICT.
- 4. THE CONTRACTOR MAY BE REQUIRED TO SUBMIT A SOIL EROSION AND SEDIMENT CONTROL PLAN FOR REVIEW AND INSPECTION TO THE WILL/SOUTH COOK SOIL AND WATER CONSERVATION DISTRICT (SWCD) AS A REQUIREMENT USACE REGIONAL PERMIT. THE PERMIT FEE WILL BE PAID FOR BY THE CHICAGO PARK DISTRICT.



ERS 250 M. Jackson Blvd.
Surte 1200
Chreage. II. 66661
ERS 2 mw.collnraengr.com

E D C B A

REVISIONS DATE

PROJECT MANAGER
PROJECT MANAGER

PROJ. MGR : AMS

DESIGNER: ELN

DRAWN: ELN
CHECKED: AMS

SCALE: As Shown
DATE: 07/31/2020

SPEC. NO.: P16015-086 JOB NO.: 7416.04


SHEET INFORMATION

JACKSON OUTER HARBOR

PARK NO./PROJECT NO.
PARK 0019
16015-086

GENERAL

02

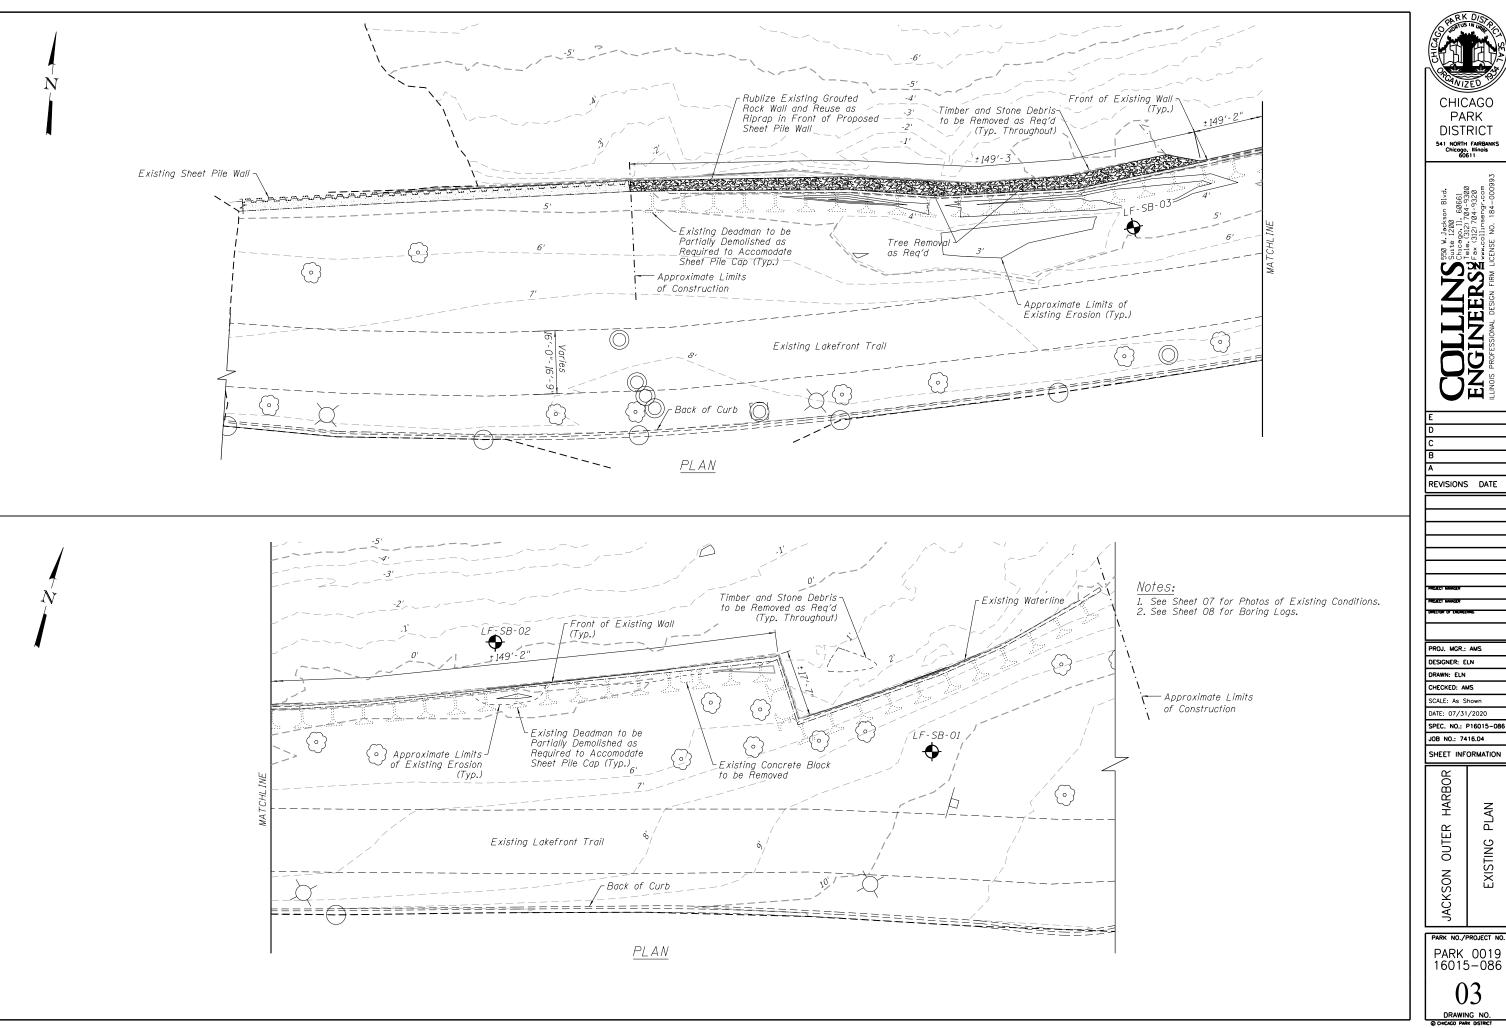

CHICAGO PARK DISTRICT

541 NORTH FAIRBANKS Chicago, Illinois 60611

REVISIONS DATE

PROJ. MGR.: AMS DESIGNER: ELN

CHECKED: AMS


SCALE: As Shown DATE: 07/31/2020

JOB NO.: 7416.04

SHEET INFORMATION

PLAN EXISTING

PARK NO./PROJECT NO. PARK 0019 16015-086

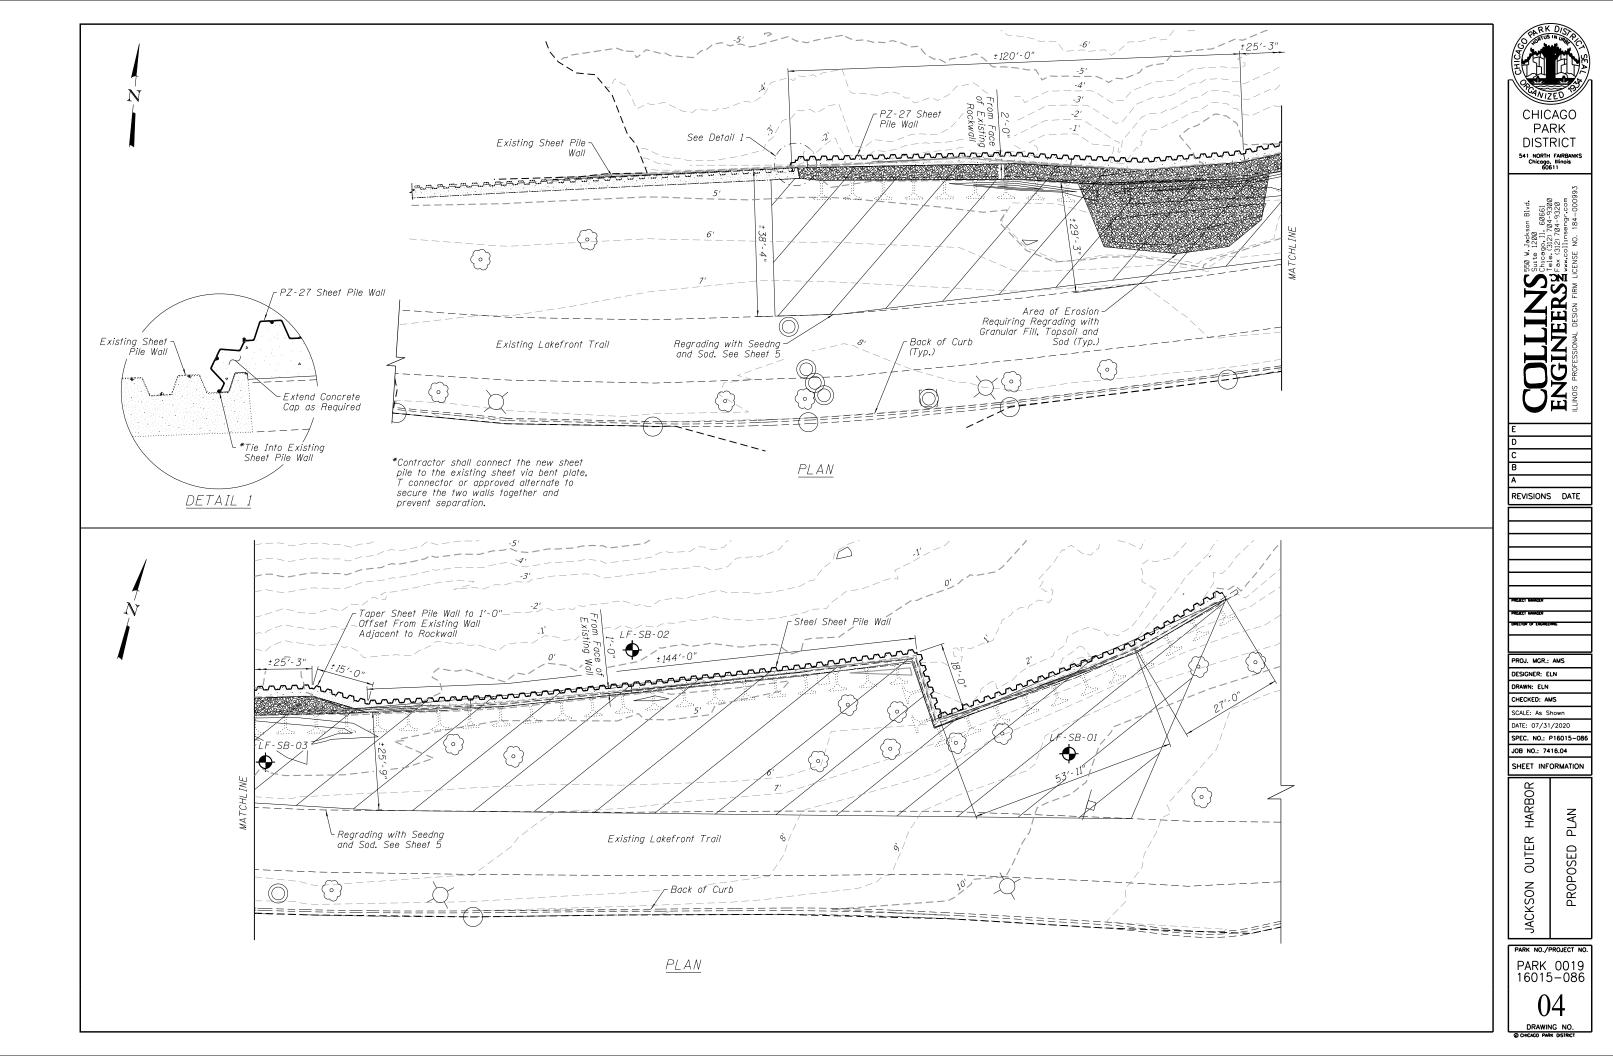



SHEET TO BE ADDED AS AN ADDENDUM

REVISIONS DATE

PROJ. MGR.: AMS

DESIGNER: ELN


DRAWN: ELN CHECKED: AMS

SCALE: As Shown DATE: 07/31/2020

SPEC. NO.: P16015-086 JOB NO.: 7416.04

SHEET INFORMATION JACKSON OUTER HARBOR

PARK 0019 16015-086

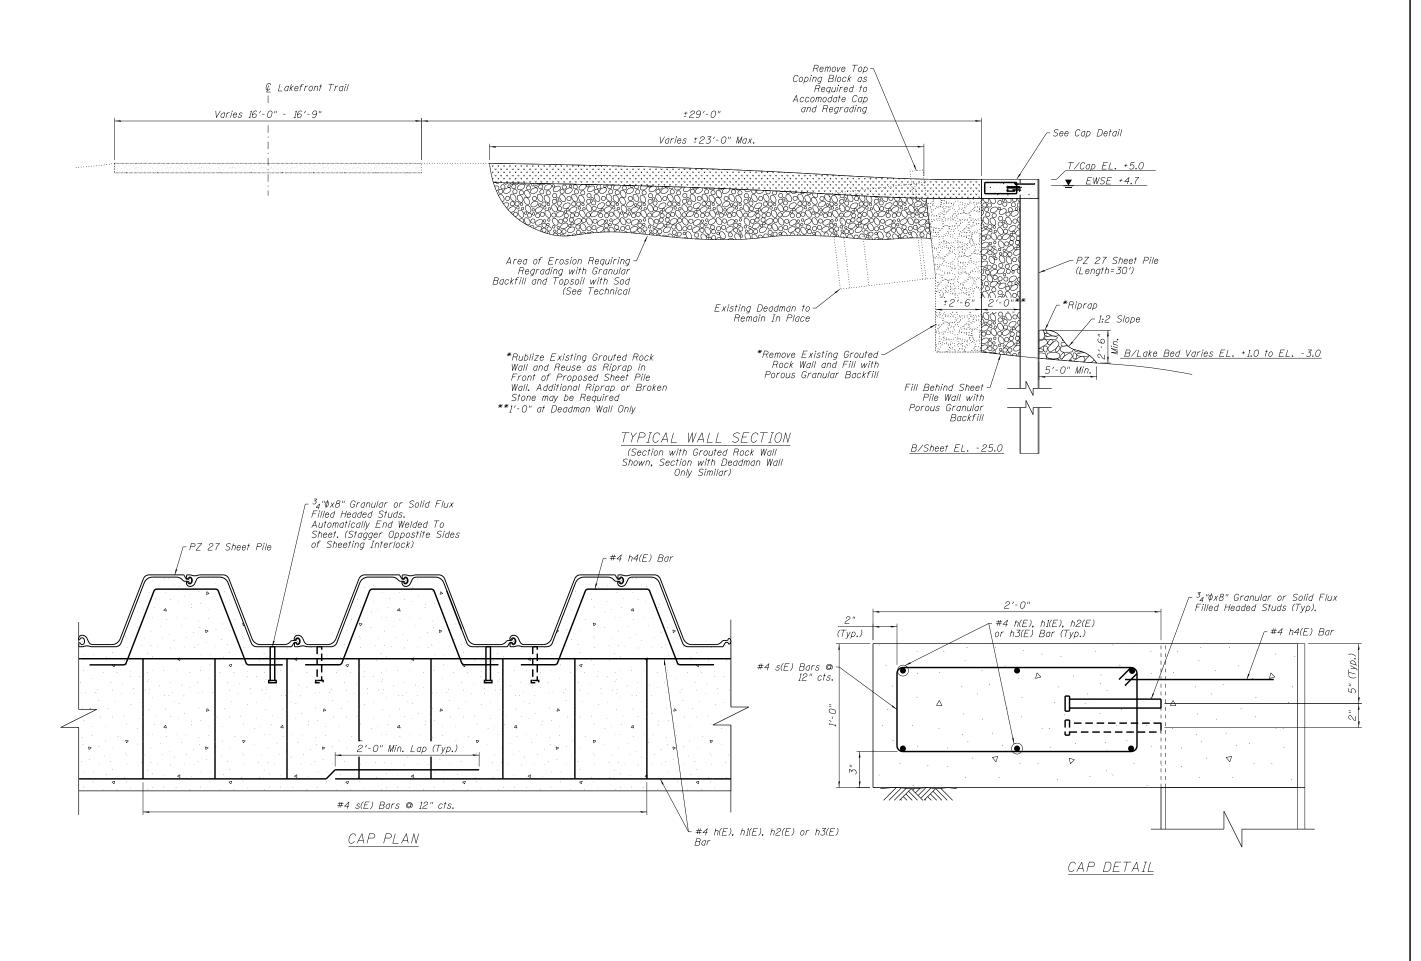

NEERS I FIRM LICENSE NO. 184-000993

E D C B A REVISIONS DATE

.....

OTEC I WWW.CER

PROJ. MGR.; AMS
DESIGNER: ELN
DRAWN: ELN

CHECKED: AMS

SCALE: As Shown

DATE: 07/31/2020

SPEC. NO.: P16015-086 JOB NO.: 7416.04

R HARBOR DETAILS

JACKSON OUTER HARBOR

શ્ર

SECTION


PARK NO./PROJECT NO.
PARK 0019
16015-086


06

DRAWING NO.

ESTIMATED BILL OF MATERIALS

| Bar | No. | Size | Length | Shape | | |
|-------------------|--------------|---------|---------|--------|--|--|
| h(E) | 18 | #4 | 28′-0" | | | |
| h1(E) | 6 | #4 | 17′-8" | | | |
| h2(E) | 48 | #4 | 38′-0" | | | |
| h3(E) | 6 | #4 | 15′-0" | | | |
| h4(E) | 128 | #4 | 4'-0" | | | |
| | | | | | | |
| s(E) | 420 | #4 | 5′-3" | | | |
| Reinfor Coated | rcment Bars, | . Ероху | Pound | 3,450 | | |
| Concre | te Structure | S | Cu. Yd. | 37 | | |
| Stud S | hear Connec | tors | Each | 256 | | |
| Perman | nent Sheet F | Piling | Sq. Ft. | 12,098 | | |

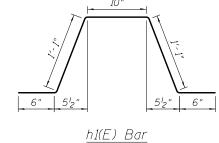

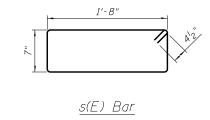

Notes:

All reinforcement shall be expoxy coated.
 Reinforcement bar detailing shall be in accordance with ACI 315 and ACI 318.

CHICAGO PARK DISTRICT

541 NORTH FAIRBANKS Chicago, Illinois 60611

REVISIONS DATE

PROJ. MGR.: AMS DESIGNER: ELN

DRAWN: ELN CHECKED: AMS

SCALE: As Shown DATE: 07/31/2020

SPEC. NO.: P16015-086 JOB NO.: 7416.04

SHEET INFORMATION

HARBOR JACKSON OUTER

DETAILS STEEL

PARK NO./PROJECT NO. PARK 0019 16015-086

DRAWING NO.



OVERALL VIEW OF WALL Looking Southeast



 $\frac{\textit{EAST END OF WALL}}{\textit{Looking South}}$



WEST END OF WALL Looking Southwest



EXISTING ROCK IN FRONT OF WALL Looking South



EROSION BEHIND EXISTING DEADMAN WALL Looking West



ROCK & DEADMAN WALL Looking West



Suite 1200
Chicago, II. 60661
Tele, (312) 704-9300
Fex (312) 704-9320
Www.collinsengr.com

COLLINS 550 Inc.
SINGINEERS From

E D C B

REVISIONS DATE

PROJECT MONGER

ORECTOR OF ENGINEERING

PROJ. MGR.: AMS

DESIGNER: ELN
DRAWN: ELN
CHECKED: AMS

SCALE: As Shown

DATE: 07/31/2020


SPEC. NO.: P16015-086 JOB NO.: 7416.04


SHEET INFORMATION

JACKSON OUTER HARBOR EXISTING CONDITION


PARK NO./PROJECT NO.
PARK 0019
16015-086

08

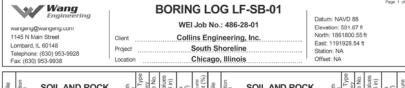

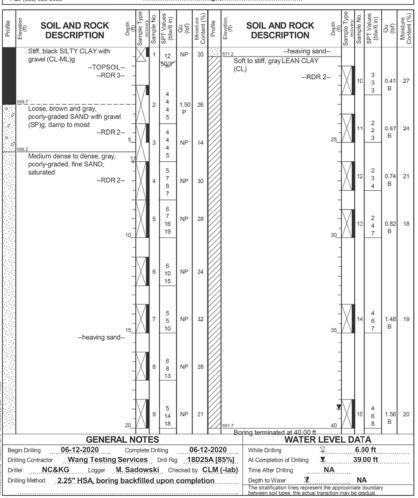

| BORING LOG LF-SB-02 Datum: NAVD 88 Elevation: 594.63 ft Natin Street Lombard, IL. 60148 Project South Shoreline Fac (630) 953-9938 Location Chicago, Illinois Offset: NA Chicago, Illinois Chicago, Illi | | | | | | | | | | | | 1 of 1 | | |
|--|--|---------------|-------------------------|------------|--------------------------|-------------|-------------------------|---|---|--|-------------|-------------------------|--|--|
| Profile | SOIL AND ROCK DESCRIPTION | Depth (ft) | Sample Type recovery | Sample No. | SPT Values (blw/6 in) | Qu (tsf) | Moisture Content (%) | Profile | Elevation (ft) | SOIL AND ROCK DESCRIPTION (f) (h) (h) (h) (h) (h) (h) (h) (h) (h) (h | Qu (tsf) | Moisture Content (%) | | |
| | Boat Deck | - | | | | | | 14 | 564.1 | Boring terminated at 20.50 ft | | | | |
| \vdash | 583.6 | \dashv | | | | | | | ' | Bolling terminated at 20.30 ft | | | | |
| | | 1 | | | | | | | | 1 | | | | |
| | | - | | | | | | | | - 1 1 | | | | |
| | | \dashv | | | | | | | | - | | | | |
| | | | | | | | | | | 1 | | | | |
| | | 4 | | | | | | | | - 11 | | | | |
| | 579.1 | 5 | | | | | | | | 25_ | | | | |
| | Water | | | | | | | | | 1 | | | | |
| 2300 | 678.1 Gray, well-graded, coarse SAND | \dashv | | | | | | | | - 1 1 | | | | |
| | (SW), trace to little gravel | \dashv | Ш | | P U | | | | | | | | | |
| | PID: 4.0ppm- | - 1 | Ш | 1 | S | NP | 26 | | | 1 | | | | |
| | PID: 0.7ppm- | . + | Ш | | Н | | | | | 4 | | | | |
| | | - | Ш | | P U | | | | | | | | | |
| | | 10_ | Ш | 2 | S | NP | 14 | | | 30_ | | | | |
| | | + | Ш | | Н | | | | | - 1 1 | | | | |
| m | Gray SILT with sand (ML)s; | \dashv | Ш | | P U | | | | | | | | | |
| | saturatedPID: 0.2ppm- | 1 | Ш | 3 | S | NP | 19 | | | 1 | | | | |
| Щ | Gray, poorly-graded, fine SAND | - | Ш | | Н | | | | | | | | | |
| | (SP); saturated | + | Ш | | P U | | | | | | | | | |
| | PID: 0.1ppm- | - [| | 4 | S | NP | 19 | | | 1 | | | | |
| | PID: 0.1ppm- | + | Н | | Н | | | | | | | | | |
| | | 15_ | | ا ِ ا | P U | NP | | | | 35 | | | | |
| | | 1 | Ш | 5 | S | NP | 22 | | | 1 | | | | |
| | PID: 0.0ppm- | . + | ₩ | | Н | | | | | | | | | |
| 1 | Very soft, gray LEAN CLAY (CL); | | Ш | , | P U | | 22 | | | 1 1 | | | | |
| | wet | 1 | | 0 | S | < 0.25 P | 27 | | |] | | | | |
| | PID: 0.0ppm- | . + | \parallel | | н | | | | | - | | | | |
| | 1 | - | | | P U | | | | | 1 | | | | |
| | | 20_ | Ш | 7 | s | < 0.25 | 26 | | | 40_ | | | | |
| | | | | | | | | | WATER LEVEL DATA | | | | | |
| Begin Drilling 06-18-2020 Complete Drilling 06-18-2020 | | | | | | | While Drilling | | | | | | | |
| Drilling Contractor Wang Testing Services Drill Rig GEOPROBE Driller NC&KG Logger F. Bozga Checked by CLM (-lab) | | | | | | | | | | | | | | |
| 61 | Drilling Method 1" IDA Pneumatic Geoprobe LB Sampler | | | | | | | | Depth to Water NA | | | | | |
| , | | | | | | | | The stratification lines represent the approximate bounda | y | - | | | | |
| | | | | | | | | | between soil types: the actual transition may be gradual. | | | | | |

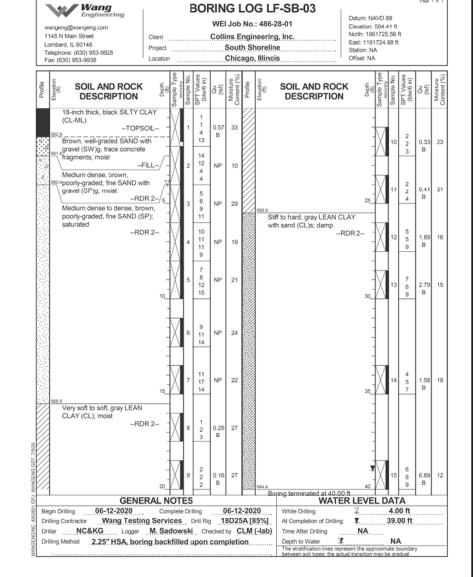

SOIL BORINGS



REVISIONS DATE PROJ. MGR.: AMS DESIGNER: ELN DRAWN: ELN CHECKED: AMS SCALE: As Shown

SHEET INFORMATION HARBOR OUTER

JACKSON

DATE: 07/31/2020

JOB NO.: 7416.04

SPEC. NO.: P16015-086

BORINGS SOIL

PARK NO./PROJECT NO. PARK_0019 16015-086

DRAWING NO.