

WESTREC MARINAS FLOATING WASHROOMS

CHICAGO, IL

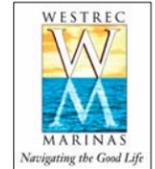
ISSUED FOR BID
JULY 18, 2011

MULLER+MULLER
architects

700 N SANGAMON
CHICAGO, IL 60622 T: 312.432.4180
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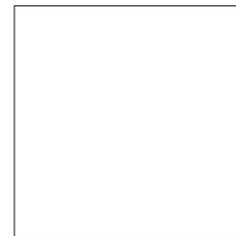
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PROJECT CONTACTS

ARCHITECT:



MULLER & MULLER, LTD.
700 N. SANGAMON ST.
CHICAGO, IL 60642
312.432.4180

SIGNED

JACOB J. MULLER, AIA
LICENSE: 010214
EXPIRES: 11/30/2012

DATE

THE ARCHITECT'S CERTIFICATION IS LIMITED TO THE BUILDING COMPONENT INDICATED ON SHEET A0.1 ONLY. WESTREC WILL COORDINATE AND VERIFY ALL DOCK ACCESSIBILITY REQUIREMENTS FOR THE DOCK (A0.1-A0.5 SHEETS) WITH ADAAG STANDARDS FOR BOATING FACILITIES.

MEP ENGINEER:



CALOR DESIGN
2217 N. WESTERN AVE.
CHICAGO, IL 60647
312.384.2700

SIGNED

DATE

STRUCTURAL ENGINEER:



SHOREMASTER
1025 INTERNATIONAL DRIVE
FERGUS FALLS, MN 56538
218.998.6672

THE STRUCTURAL ENGINEER'S STAMP IS LIMITED TO BARGE MANUFACTURING AND DESIGN.

SIGNED

DATE

PROJECT VICINITY MAPS



PROJECT SITE:
**BELMONT HARBOR
DOCK F - SOUTH SIDE**
SEE A0.1



PROJECT SITE:
**DIVERSEY HARBOR
DOCK G - SOUTH SIDE**
SEE A0.2



PROJECT SITE:
**JACKSON OUTER HARBOR
DOCK D - NORTH SIDE**
SEE A0.3



PROJECT SITE:
**BURNHAM HARBOR SOUTH
DOCK P - NORTH SIDE**
SEE A0.5

PROJECT SITE:
**BURNHAM HARBOR NORTH
DOCK F - NORTH SIDE**
SEE A0.4

PROJECT DATA

BUILDING AREA (GROSS) 576 SF
NUMBER OF STORIES 1
BARGE DIMENSIONS 42' x 26' (L x W)
ESTIMATED WEIGHT OF BUILDING ± 58,000 LBS
(GC TO CALCULATE WEIGHT AND SUBMIT TO WESTREC SEE BIDDING NOTE 4.)

APPLICABLE CODES

SEE GENERAL NOTES - PERMIT

DRAWING INDEX

G0.0	COVER SHEET
G0.1	GENERAL NOTES, ABBREVIATIONS & SYMBOLS
2-03092*	SHOREMASTER BARGE DRAWING - TYPICAL FACILITY
2-03092-1*	SHOREMASTER BARGE DRAWING - JACKSON FACILITY
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A0.2	SITE PLAN - DIVERSEY HARBOR
A0.3	SITE PLAN - BURNHAM HARBOR NORTH
A0.4	SITE PLAN - BURNHAM HARBOR SOUTH
A0.5	SITE PLAN - JACKSON HARBOR
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A1.1J	FLOOR PLAN - JACKSON
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A5.2	WALL SECTIONS
A6.1	INTERIOR ELEVATIONS AND DETAILS
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A6.3	INTERIOR ELEVATIONS AND DETAILS
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A8.1	SCHEDULES AND DETAILS
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A8.3	ENLARGED DETAILS
A9.3	ENLARGED DETAILS
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P1-2	PLUMBING FLOOR PLAN - WATER
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P2-2	PLUMBING SCHEDULES
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P3-1	PLUMBING RISERS
P3-1J	PLUMBING RISERS (JACKSON)
P4-1	PLUMBING SYMBOLS AND DETAILS

* INDICATES DRAWINGS FOR REFERENCE ONLY



GENERAL NOTES

GENERAL NOTES- SCOPE

This project generally consists of the construction of a one story 576 square foot building with 6 single-use public restrooms with showers, one laundry unit, and associated mechanical, electrical, and plumbing components. The building is cold-formed metal frame construction built on a floating barge (barge by Westrec) and floated to the location in the harbor indicated on the project vicinity maps.

GENERAL NOTES- PERMIT

- All interior finishes to be at least Class 1 Flame Spread Rating of 0-25.7 (15-12-340).
- All exit door to be keyless in the direction of travel from rooms having a capacity not exceeding 50 persons. 10(13-100-250(e)).
- See sheet A8.1 for partition types.
- All glass in doors to be tempered safety glass.
- Code jurisdiction and permit approval for this project are under the Chicago Department of Transportation. Separate from the CDOT permit, the contractor is required to apply and pay for electrical permit through the Department of Buildings. The contractor shall perform all work in accordance with the latest edition of the City of Chicago Building Code and all applicable county, state, and federal laws, including the Occupational Safety and Health Act (OSHA) and regulations adopted pursuant thereto.
- The general contractor is responsible for applying, procuring, and paying for all permits and inspections required to complete the scope of work unless noted otherwise.
- All gypsum board to be type 'x' unless noted otherwise.

GENERAL NOTES- BIDDING

- The contractor is responsible for contracting with the barge manufacturer selected by Westrec (Company name: Shoremaster Dock Company, contact: Mike Plemmons, phone: 573.216.3655). Contracting will be at the price indicated by Westrec. Contractor will handle all coordination of the barge manufacturer, including construction at Crowley's boatyard of all five barges/washroom buildings simultaneously and transporting them to the individual sites after the first punch list is completed.

**** Some of the following "general notes - bidding" may be in conflict with the project front end. The following notes supersede the requirements of the front end.

- Upon award of contract, GC will determine the exact weight of the building and coordinate with the barge manufacturer for all adjustments required as part of the GC's base bid. Estimated weights by the design team are approximate only based on 90% drawings.
- Any details, systems, materials, (i.e. architectural, structural, electrical, etc.) which are proposed to be changed or substituted must first be reviewed and approved by the owner prior to the preparation and submittal of shop drawings. The owner reserves the right to reject substitutions. The contractor is responsible for added job costs due to higher substitutions and impacts on other trades.
- Submittals: General Contractor shall submit all materials and layouts to Westrec for review and approval, including catalog cuts with product data, samples, design data, test reports, and shop drawings for all materials. For items specified as "selected by owner", the general contractor is to obtain product information from the owner and submit to Westrec for confirmation. The General Contractor shall coordinate a preliminary meeting with Westrec and door manufacturer prior to submission of any exterior door shop drawings. All submittals, with the exception of samples shall be submitted electronically in .pdf format via email unless directed otherwise by Westrec.
- The contractor is to provide record as-built drawings with any changes to the drawings and detailed information for MEP systems. Provide (3) copies of as-builts and (3) CD's after architect's approval of as-builts (architect, Westrec, Chicago Park District).
- General Contractor to provide warranty for all work and material from the date of substantial completion through September of 2012.
- General contractor to provide one final cleaning at the direction of the tenant owner.
- Temporary Utilities at boat yard will be paid for by GC.
- Prior to submission of bid, General Contractor shall visit the site and be knowledgeable of all conditions thereon, he or she shall investigate, verify, and be responsible for all conditions of the project and shall notify the owner of any conditions requirement modification or clarification before proceeding with the work. The contractor is responsible for all means, methods, and techniques to implement the design as part of their base bid.
- Notes appear on various sheets for different systems and materials. Notes on any one sheet are to be applied to related drawings and details. When there are discrepancies between drawings and specifications, consult the owner during the bid period for any clarifications needed prior to submission of bid. If the owner is not consulted during the bid period, the more stringent requirement shall apply.

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4	07/01/2011	100% DESIGN SUBMITTAL
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1	01/20/2011	SCHEMATIC DESIGN

PROJECT
**WESTREC FLOATING
WASHROOMS**

SHEET TITLE
COVER SHEET

DRAWN: NAP	SHEET NO.
CHECKED: TS	G0.0
APPROVED: TS	
JOB NO. 10.09.10	

ARCHITECTURAL ABBREVIATIONS

ADA	AMERICAN WITH DISABILITIES ACT	GA	GAUGE	PD	PLANTER DRAIN
AFF	ABOVE FINISHED FLOOR	GALV	GALVANIZED	PJF	PREMOLDED JOINT FILLER
ACT	ACOUSTICAL TILE	GC	GENERAL CONTRACTOR	PL	PLATE
ADJ	ADJACENT	GFCMU	GROUND FACE CONCRETE MASONRY UNIT	P	PLASTIC
A/C	AIR CONDITIONING	GFI	GROUND FAULT INTERRUPTER	PLBG	PLUMBING
ALUM	ALUMINUM	GL	GLASS, GLAZING	PLYWD	PLYWOOD
APPROX	APPROXIMATE(LY)	GLCMU	GLAZED CONCRETE MASONRY UNIT	PORC	PORCELAIN TILE
BM	BEAM	GYP	GYPSUM	PR	PAIR
BTWN	BETWEEN	GWB	GYPSUM WALL BOARD	PREFAB	PREFABRICATE(D)
BIT	BITUMINOUS	HB	HOSE BIB	PT	POINT
BLKG	BLOCKING	HBG	HIGH BARRIER GATE	PTD	PAINTED
B/	BOTTOM OF BUILDING	HC	HOLLOW CORE	PVC	POLYVINYL CHLORIDE
BLDG	BUILDING	HDWD	HARDWOOD	PVMT	PAVEMENT
CAB	CABINET	HGT	HEIGHT	QT	QUARRY TILE
CI	CAST IRON	HM	HOLLOW METAL	R	RISER
CIP	CAST IN PLACE	HORIZ	HORIZONTAL	RD	ROOF DRAIN
CB	CATCH BASIN	HP	HIGH POINT	REINF	REINFORCE(D)(ING)
CLG	CEILING	HDRW	HARDWARE	REQ'D	REQUIRED
CJ	CONTROL JOINT	HW	HOT WATER	RET	RETURN
CL	CENTERLINE	HWH	HOT WATER HEATER	RH	RIGHT HAND
CT	CERAMIC TILE	ID	INSIDE DIAMETER	RM	ROOM
CLOS	CLOSET	IN	INCH(ES)	RO	ROUGH OPENING
CLR	CLEAR(ANCE)	INCL	INCLUDE(D)(ING)	SAN	SANITARY
CMU	CONCRETE MASONRY UNIT	INFO	INFORMATION	SC	SILL COCK
CO	CLEAN OUT	INSUL	INSULATION	SCHED	SCHEDULE
COL	COLUMN	INT	INTERIOR, INTERNAL	SCWD	SOLID CORE WOOD DOOR
CONC	CONCRETE	J.C.	JANITOR'S CLOSET	SCONC	SEALED CONCRETE
CONST	CONSTRUCTION	JST	JOIST	SD	SITE DRAIN
CONT	CONTINUOUS	JT	JOINT	SFCMU	SPLIT FACE CONCRETE MASONRY UNIT
CORR	CORRIDOR	KS	KITCHEN SINK	SGFT	STRUCTURAL GLAZED FACING TILE
CPT	CARPET	LAM	LAMINATE(D)	SH	SHOWER
CRS	COURSE(S)	LAV	LAVATORY	SHT	SHEET
CW	COLD WATER	LB(S)	POUND(S)	SIM	SIMILAR
CO	CLEAN OUT	LF	LINEAR FEET	SQ	SQUARE
DIA	DIAMETER	LH	LEFT HAND	STGT	STRUCTURAL GLAZED TILE
DIM	DIMENSION	LLH	LONG LEG HORIZONTAL	STL	STEEL
DBL	DOUBLE	LLV	LONG LEG VERTICAL	SS	STAINLESS STEEL
DN	DOWN	LP	LOW POINT	SUSP	SUSPENDED
DF	DRINKING FOUNTAIN	LTL	LINTEL	T	TREAD
DS	DOWN SPOUT	MAT	MATERIAL(S)	T/	TOP OF
DWG	DRAWING	MAX	MAXIMUM	T & B	TOP AND BOTTOM
EA	EACH	MECH	MECHANICAL	T & G	TONGUE AND GROOVE
EJ	EXPANSION JOINT	MEZZ	MEZZANINE	TD	TRENCH DRAIN
EL	ELEVATION	MFR	MANUFACTURE(R)(D)	TEL	TELEPHONE
ELEC	ELECTRICAL	MH	MANHOLE	TERR	TERRAZZO
ENCL	ENCLOSURE	MIN	MINIMUM	TYP	TYPICAL
EC	END CABINET	MISC	MISCELLANEOUS	UNEX	UNEXCAVATED
ENTR	ENTRANCE	MO	MASONRY OPENING	UNFIN	UNFINISHED
EQ	EQUAL	MTD	MOUNTED	UNO	UNLESS NOTED OTHERWISE
EQPT	EQUIPMENT	MTG	MOUNTING	UR	URINAL
EWC	ELECTRIC WATER COOLER	MTL	METAL	VB	VINYL BASE
EXH	EXHAUST	MWK	MILLWORK	VCT	VINYL COMPOSITION TILE
EXIST	EXISTING	NIC	NOT IN CONTRACT	VERT	VERTICAL
EXP	EXPOSED	NO	NUMBER	VIF	VERIFY IN FIELD
EXT	EXTERIOR	NOM	NOMINAL	VTR	VENT THROUGH ROOF
EP	EPOXY PAINT	NTS	NOT TO SCALE	W/	WITH
FD	FLOOR DRAIN	OC	ON CENTER	WC	WATER CLOSET
FDN	FOUNDATION	OD	OUTSIDE DIAMETER	WD	WOOD
FE	FIRE EXTINGUISHER	OPNG	OPENING	WH	WALL HUNG
FIN	FINISH(ED)	OH	OPPOSITE HAND	WM	WIRE MESH
FF	FINISHED FLOOR			WP	WATERPROOF(ING)
FLR	FLOOR			WPT	WORKING POINT
FLUOR	FLUORESCENT			WR	WATER RESISTANT
FT	FEET, FOOT			WT	WEIGHT
FTG	FOOTING			WWF	WELDED WIRE FABRIC

ARCHITECTURAL TARGET LEGEND

	ELEVATION NUMBER	BUILDING ELEVATIONS
	SHEET NUMBER	BUILDING ELEVATIONS
	DETAIL NUMBER	BUILDING SECTIONS
	SHEET NUMBER	BUILDING SECTIONS
	DETAIL NUMBER	WALL/DETAIL SECTIONS
	SECTION NUMBER	WALL/DETAIL SECTIONS
	SHEET NUMBER	WALL/DETAIL SECTIONS
	DETAIL NUMBER	ENLARGED PLAN/SECTION/ELEVATION
	SHEET NUMBER	ENLARGED PLAN/SECTION/ELEVATION
	ELEVATION NUMBER	INTERIOR ELEVATIONS
	SHEET NUMBER	INTERIOR ELEVATIONS
	DOOR NUMBER	DOOR TARGET
	COLUMN NUMBER	COLUMN INDICATORS
	PARTITION TYPE	PARTITION TARGET
	ROOM NAME	ROOM TARGET
	ROOM NUMBER	ROOM TARGET
	LOCATION AND ELEVATION	ELEVATION MARK
	REVISION NUMBER	REVISION MARK
	ACCESSORY NUMBER	PLUMBING MARK
	SIGN NUMBER	SIGNAGE MARK

ARCHITECTURAL SYMBOL LEGEND

	FLUORESCENT FIXTURE (SUSPENDED)
	DOWNLIGHT
	SPEAKER
	EXIT SIGN
	CEILING MTD. LIGHT FIXTURE
	SWITCH
	DUPLEX RECEPTACLE
	QUAD RECEPTACLE
	DATA RECEPTACLE
	TELEPHONE RECEPTACLE
	HVAC SUPPLY REGISTER
	HVAC RETURN REGISTER
	FORCED AIR HEATER
	SPRINKLER HEAD
	FLOOR DRAIN
	MOP BASIN
	WATER CLOSET
	LAVATORY
	SITE DRAIN
	LIGHT POLE
	EXISTING LIGHT POLE

ARCHITECTURAL MATERIAL LEGEND

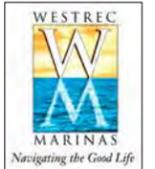
	ACOUSTICAL TILE
	SEALANT
	TILE (WALL OR FLOOR)
	CONCRETE
	CONCRETE BLOCK
	BRICK
	CAST STONE
	EARTH
	STRUCTURAL GLAZED TILE
	GRAVEL
	GYPSUM BOARD
	BATT INSULATION
	RIGID INSULATION
	MORTAR NET
	PREMOULDED FILLER
	ALUMINUM
	STEEL
	STEEL - SMALL SCALE
	PLYWOOD
	FINISH WOOD
	DIMENSIONAL LUMBER
	BLOCKING
	GLAZING - LARGE SCALE

ARCHITECTURAL GENERAL NOTES

GENERAL NOTES- CONSTRUCTION

- All dimensions are face of partitions, column centerline, or finished face of exterior wall unless otherwise noted.
- All dimensions shall be verified in the field before proceeding with any work. The owner shall be notified of any discrepancies or corrections. Dimensions of new work are based on record drawings of existing work. Any discrepancies in existing work will affect new work dimensions. Contractor is to verify the drawings.
- Provide access panels as required by applicable codes and as required for mechanical and electrical equipment. Review locations with owner and architect at a pre-installation conference.
- All dissimilar metals shall be effectively isolated.
- The contractor must coordinate all mechanical and electrical floor sleeves and wall sleeves, embedded conduit, and mechanical ductwork with mechanical, plumbing, electrical, and architectural drawings with corresponding disciplines.
- All pipes, conduits, and ductwork that penetrate walls, floor, or roof shall be installed in a manner that will preserve the fire resistive integrity and water tightness of such walls or slabs and the building.
- All exterior joints around windows, doors frames, metal panels, between walls and roof, between wall panels, and at penetrations of utilities through the building envelope shall be fire-rated as required, sealed, caulked, or weather stripped to prevent water or air leakage/penetration.
- Coordinate top of finished floor to match top of existing dock. Coordinate the proper flat height with Westrec and the barge manufacturer. The General Contractor is responsible for all coordination and verifying heights and dimensions of each site.
- General Contractor coordinate with structural and site plan drawings. Drawings that represent the existing plan conditions are diagrammatically shown. Exact locations, sizes, extent, and conditions of existing construction to be removed, relocated, or to remain shall be verified on the building site by the contractor and included in the work scope and bid.
- Contractor shall be responsible for protection of existing and new work. Any work damaged for any reason shall be replaced at no cost to the owner.
- The submission of a bid or proposal will be construed as evidence that the contractor has familiarized himself with the plans and existing conditions of the building site. Claims made subsequent to the proposal for materials and labor because of difficulties encountered will not be recognized if they could have been foreseen had proper examination of the site and/or drawings been made.
- Prior to starting construction the general contractor shall be responsible to verify that all required permits and approvals have been obtained. Neither construction nor fabrication of any item shall begin until the contractor has received all plans and any other approvals from governmental agencies or other regulatory authorities having jurisdiction over the project. Failure of the contractor to follow this procedure shall cause the contractor to assume full responsibility for any subsequent modification of the work mandated by regulatory authority.
- All gypsum board to be 5/8" abuse resistant and moisture resistant unless noted otherwise. In wet areas cement board shall be used.
- Contractor shall install rough blocking or wood nailers during the rough framing stage of construction as required for properly securing wall cabinets, shelving, lighting, and electrical fixtures, wall mounted equipment, millwork, toilet accessories, applied decorative treatments, and handrail brackets.
- Newly installed exposed electrical items, including the plumbing chase, including but not limited to, conduit hangers, and fittings shall be painted to match existing adjacent surfaces unless drawings indicate a wall or ceiling to remain unfinished (not painted).
- Contractor to remove any graffiti within 24 hours during construction.

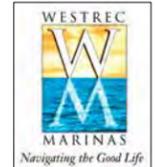
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WESTREC FLOATING WASHROOMS

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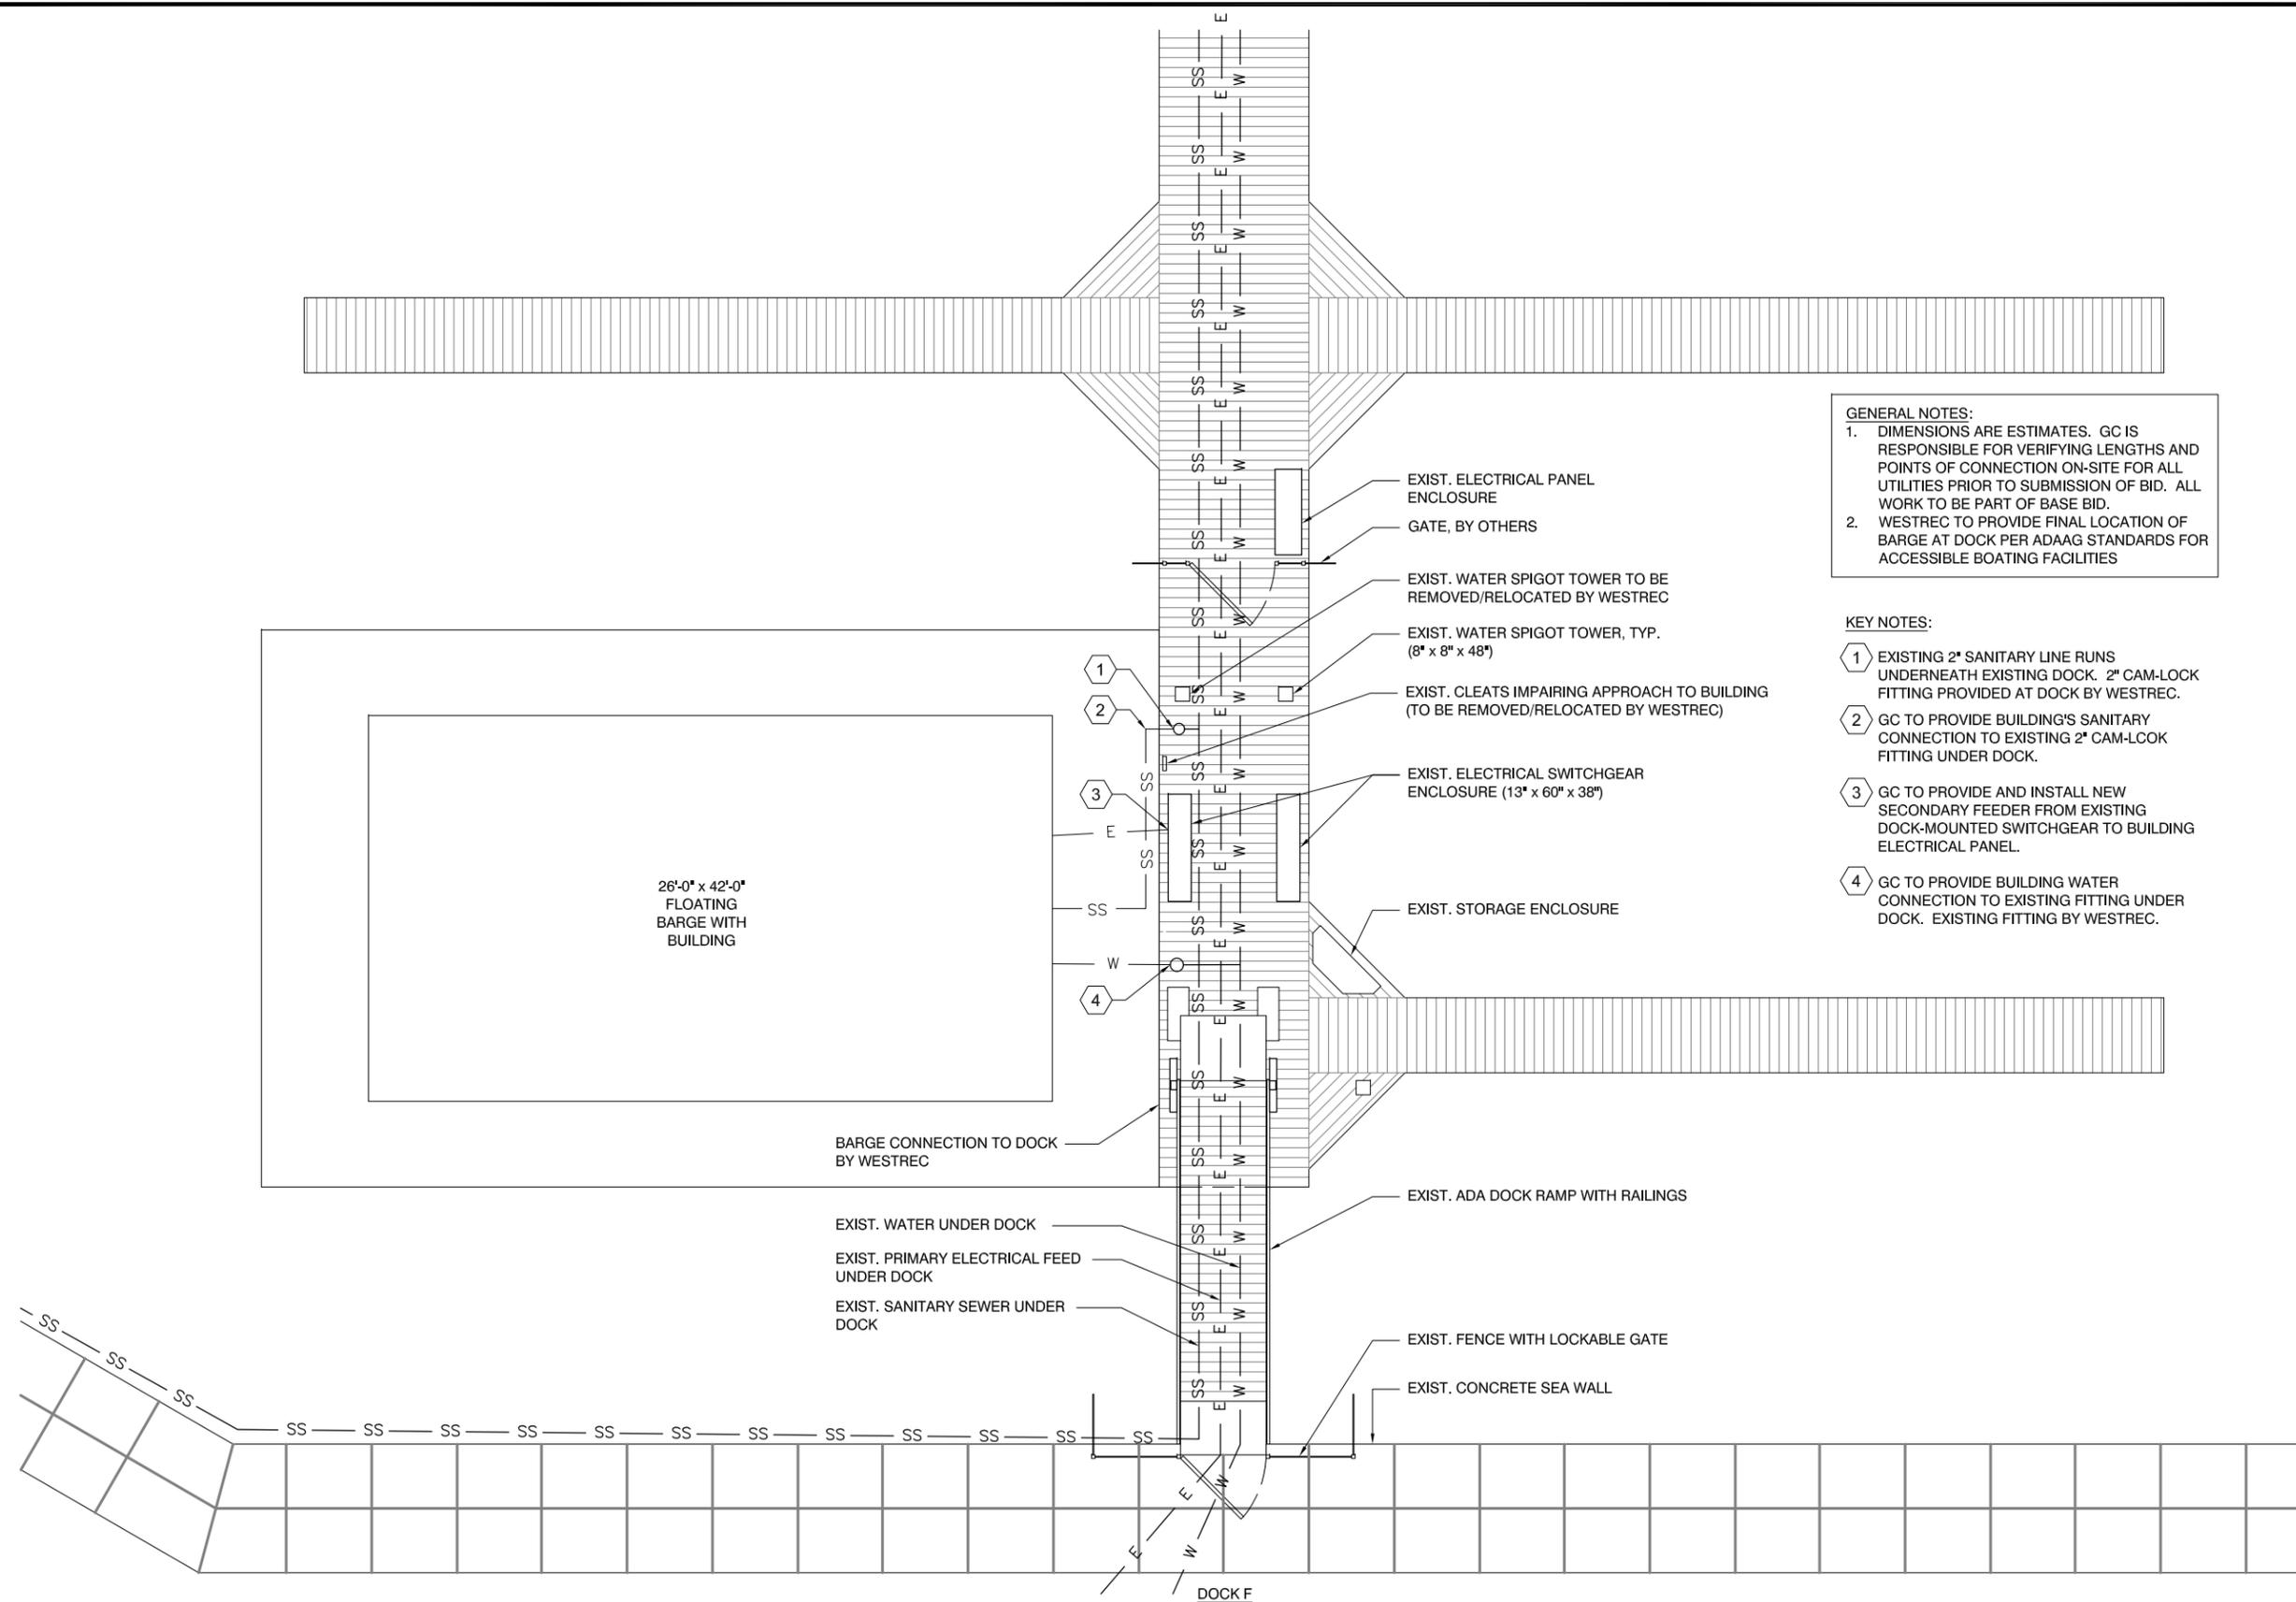


GENERAL NOTES:

- DIMENSIONS ARE ESTIMATES. GC IS RESPONSIBLE FOR VERIFYING LENGTHS AND POINTS OF CONNECTION ON-SITE FOR ALL UTILITIES PRIOR TO SUBMISSION OF BID. ALL WORK TO BE PART OF BASE BID.
- WESTREC TO PROVIDE FINAL LOCATION OF BARGE AT DOCK PER ADAAG STANDARDS FOR ACCESSIBLE BOATING FACILITIES

KEY NOTES:

- EXISTING 2" SANITARY LINE RUNS UNDERNEATH EXISTING DOCK. 2" CAM-LOCK FITTING PROVIDED AT DOCK BY WESTREC.
- GC TO PROVIDE BUILDING'S SANITARY CONNECTION TO EXISTING 2" CAM-LOCK FITTING UNDER DOCK.
- GC TO PROVIDE AND INSTALL NEW SECONDARY FEEDER FROM EXISTING DOCK-MOUNTED SWITCHGEAR TO BUILDING ELECTRICAL PANEL.
- GC TO PROVIDE BUILDING WATER CONNECTION TO EXISTING FITTING UNDER DOCK. EXISTING FITTING BY WESTREC.



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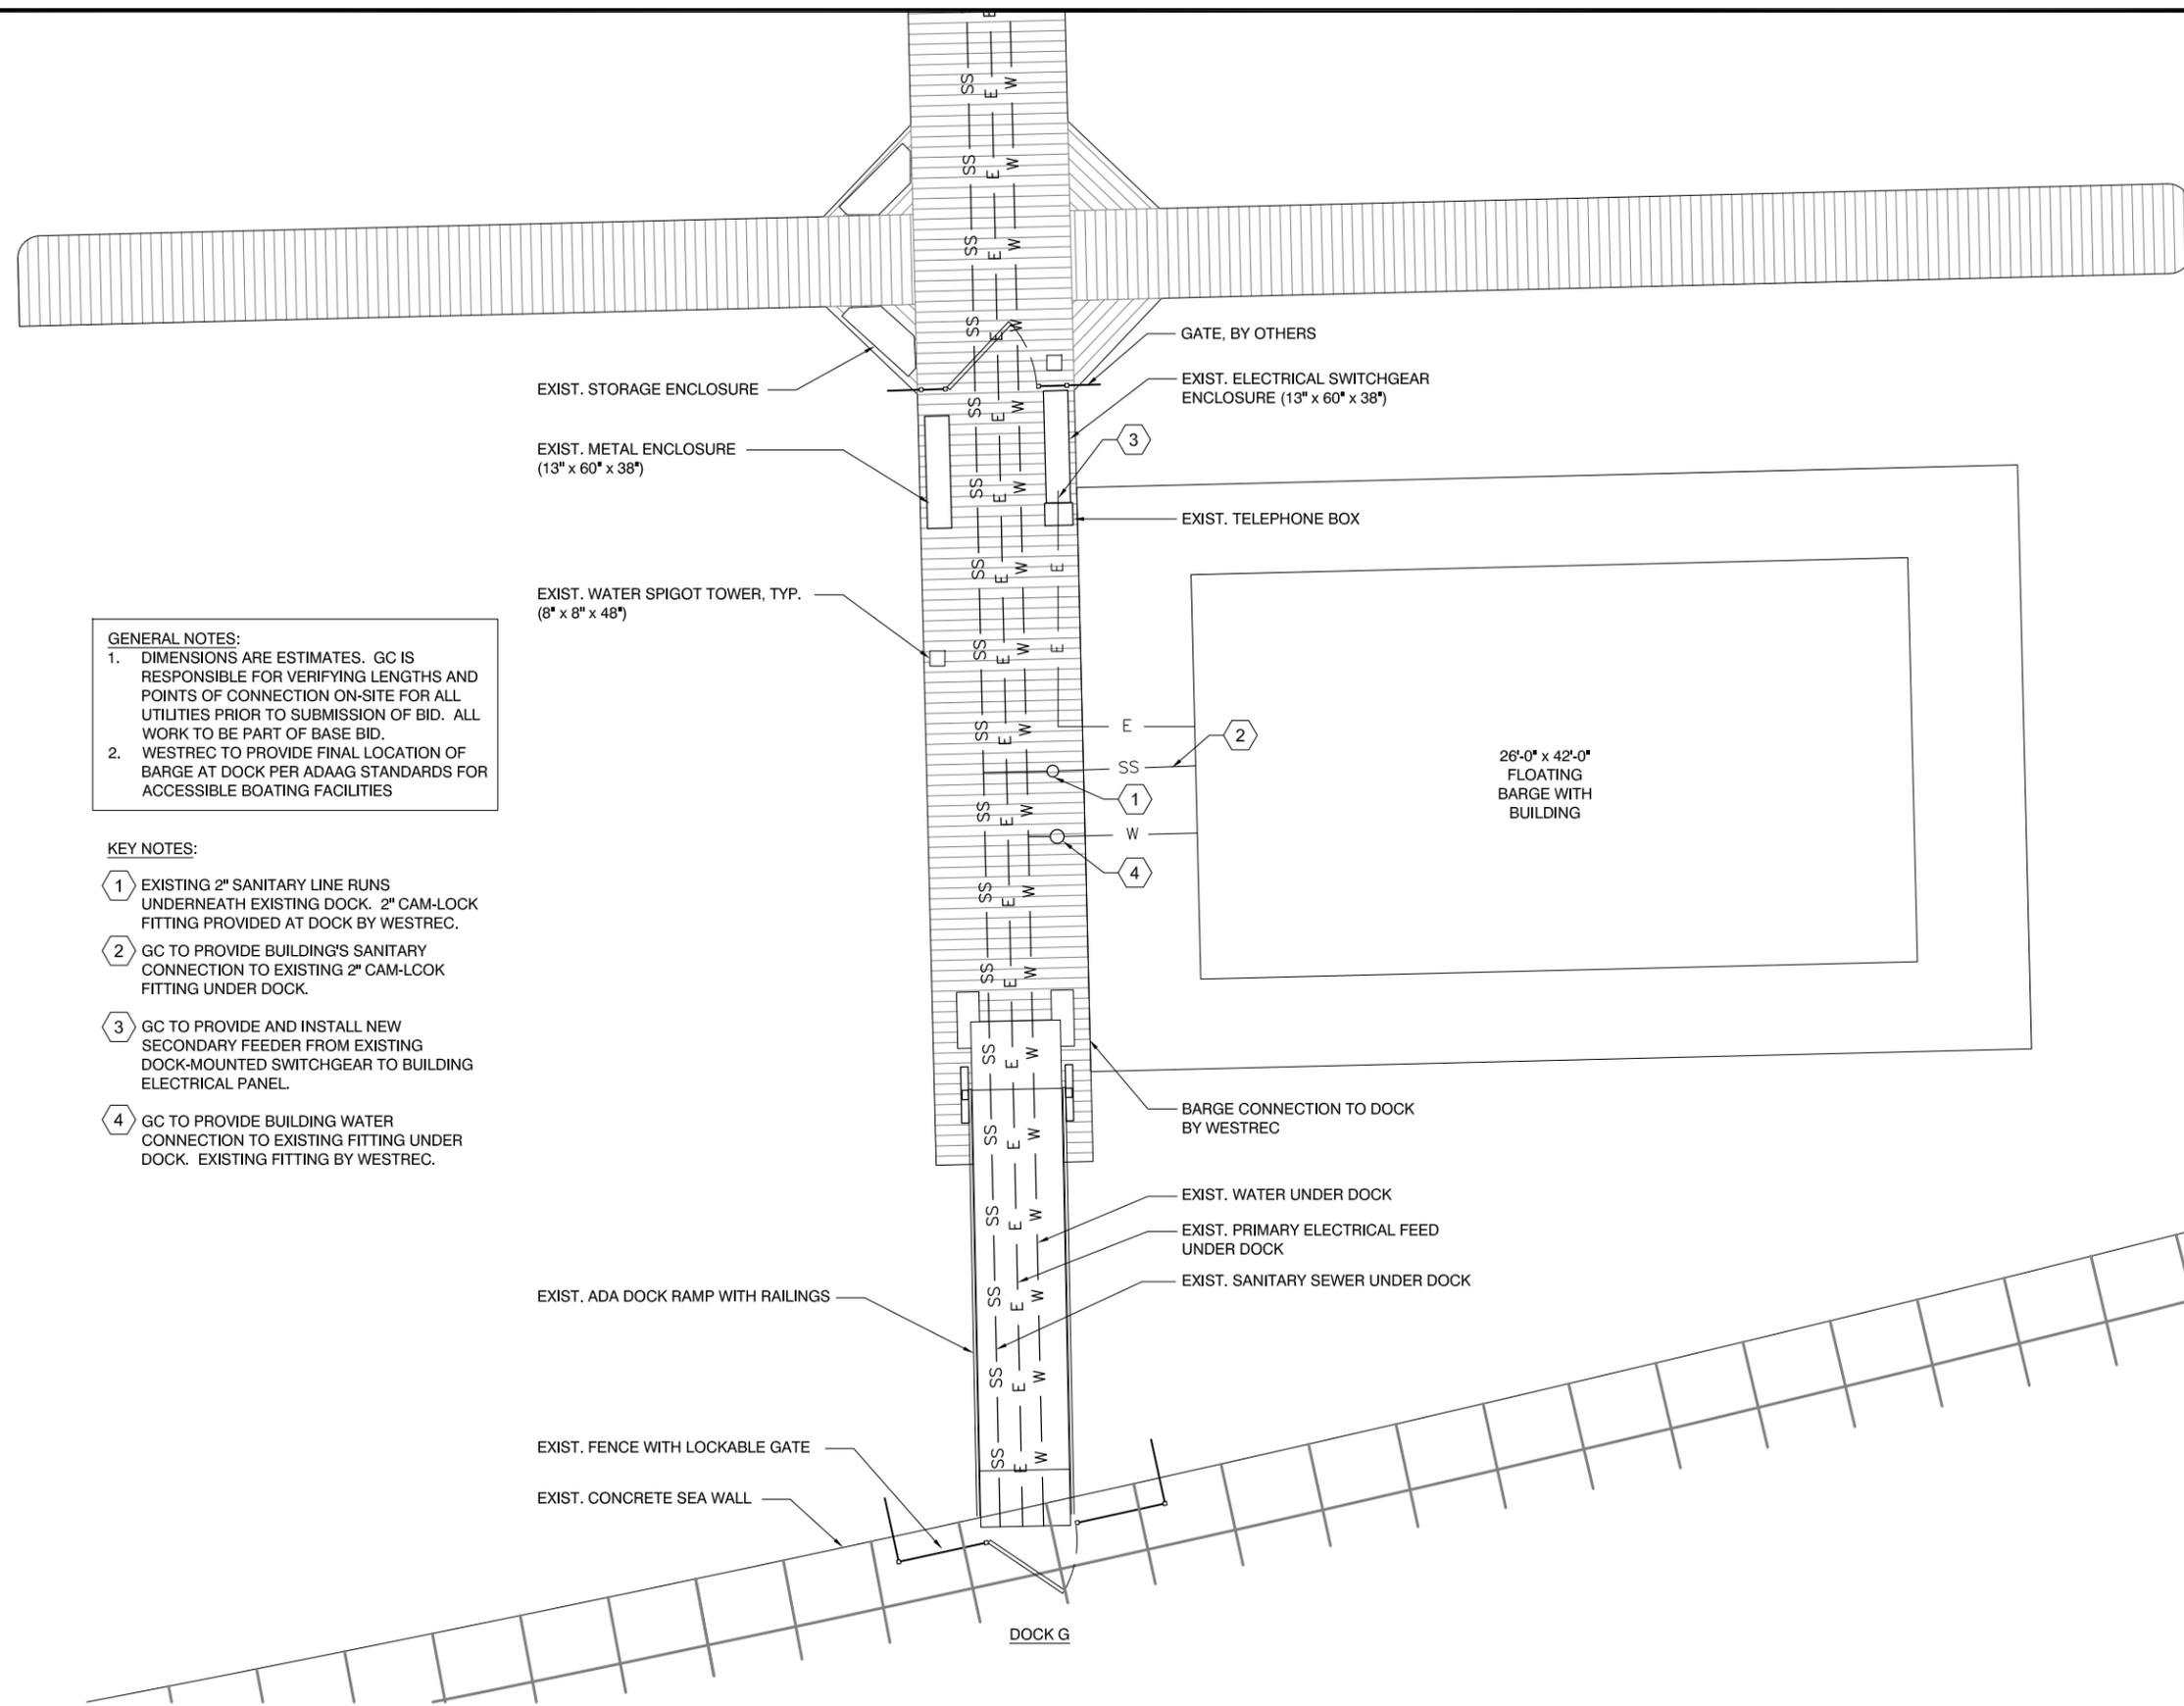
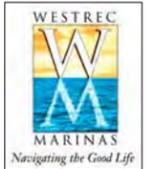
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WESTREC FLOATING WASHROOMS

SHEET TITLE
SITE PLAN - BELMONT

DRAWN: NAP	SHEET NO.
CHECKED: TS	A0.1
APPROVED: TS	
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1 SITE PLAN - BELMONT HARBOR - DOCK F
SCALE: 1/8" = 1'-0"

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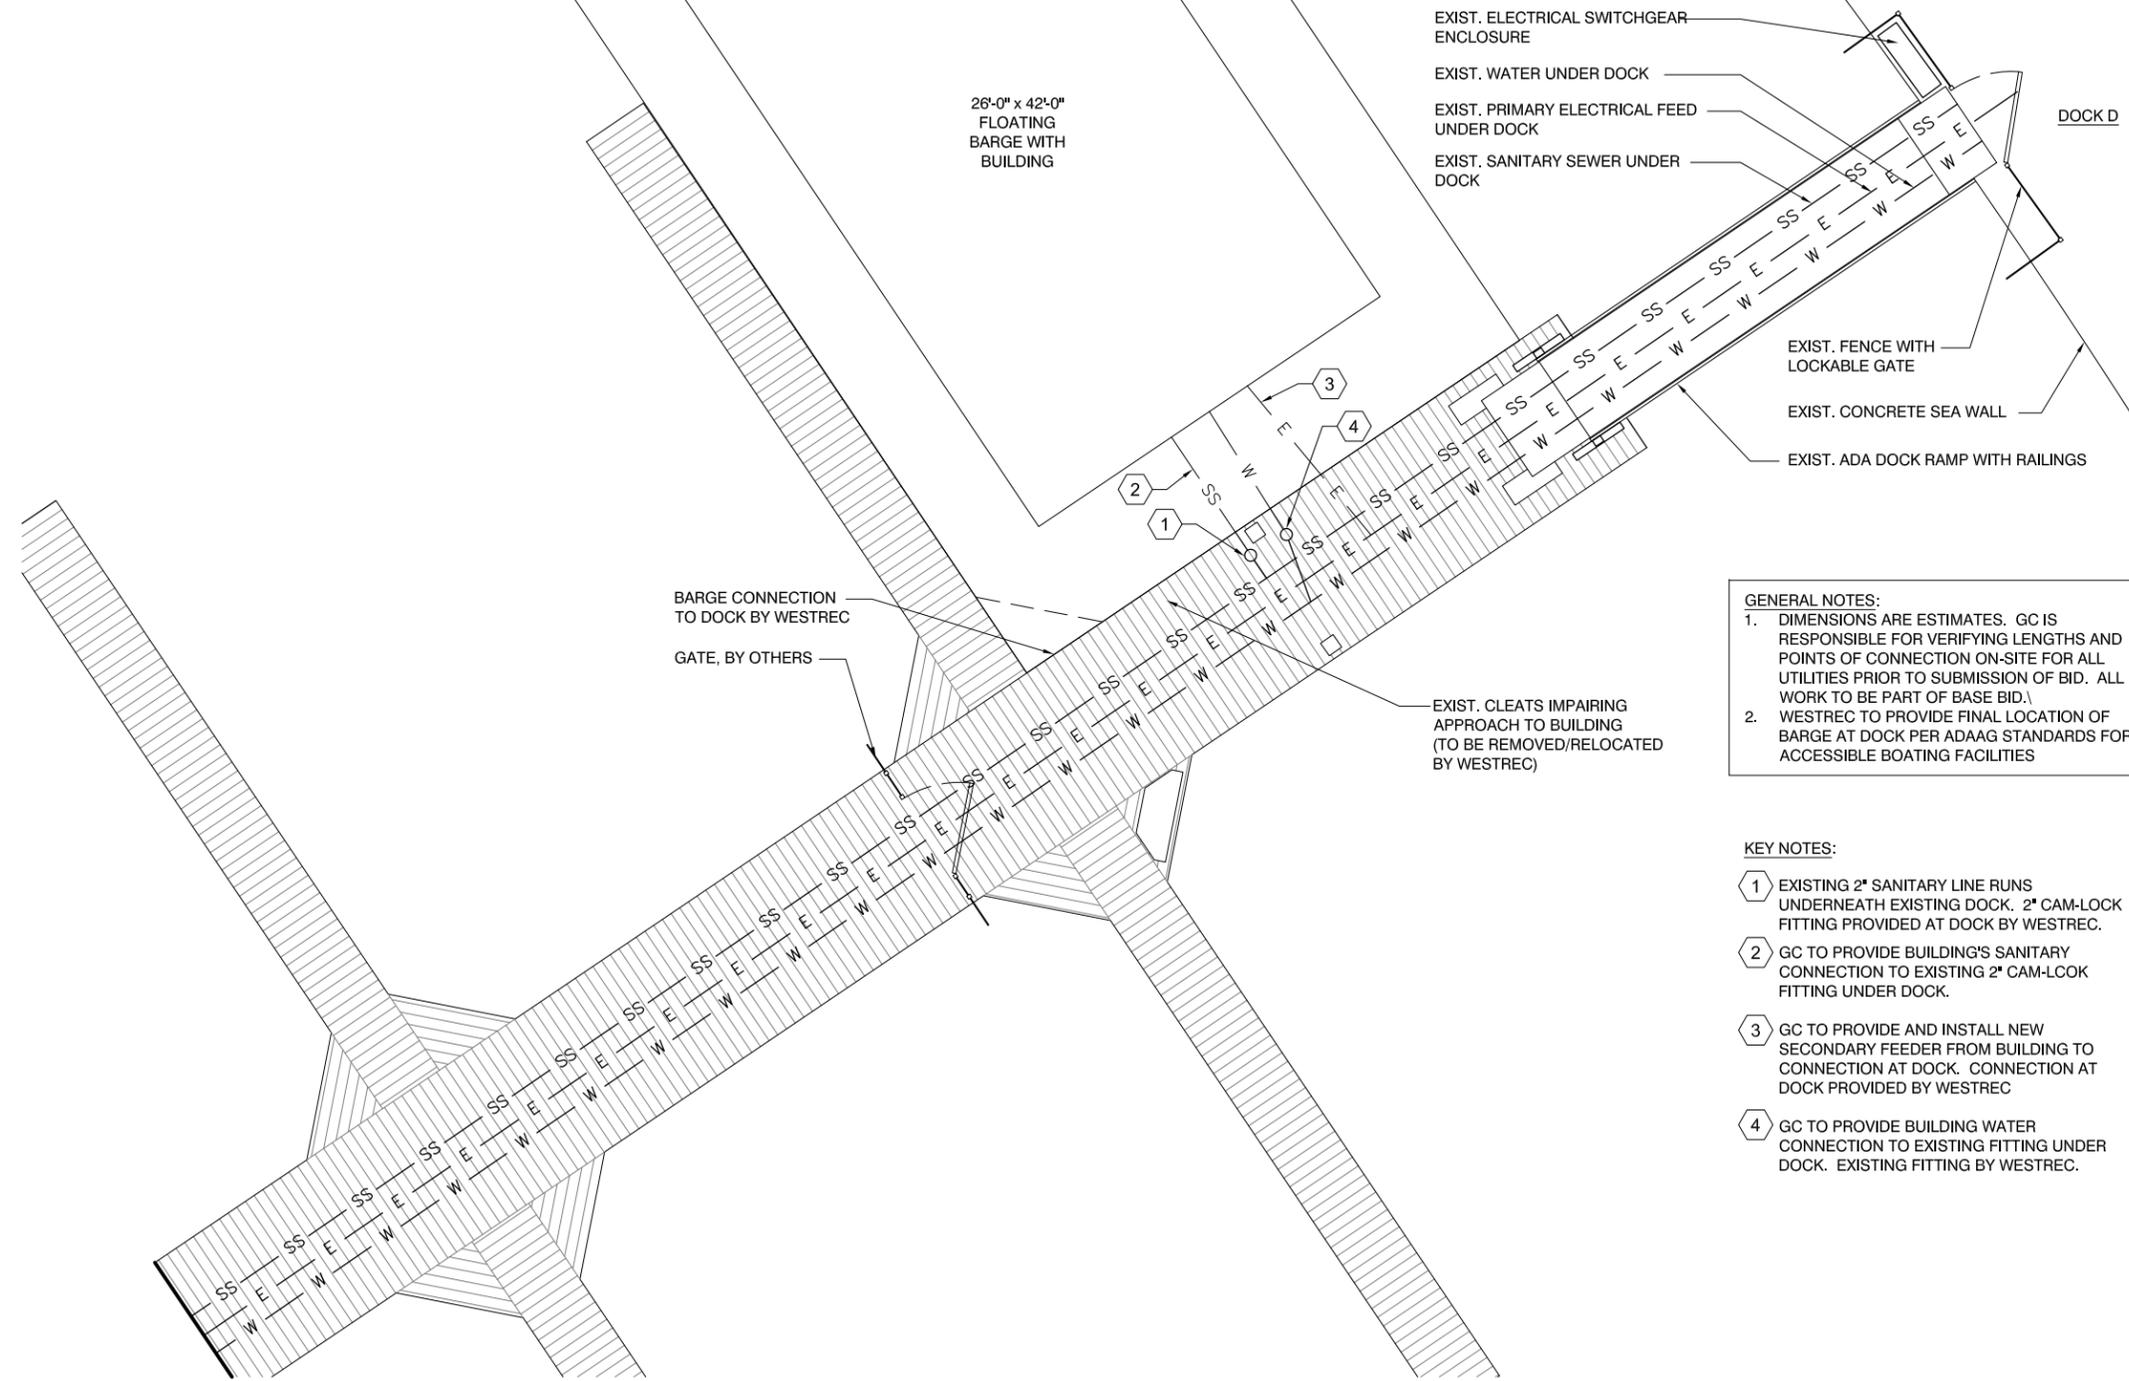
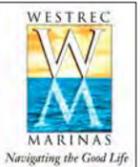
SHEET TITLE
SITE PLAN - DIVERSEY

DRAWN: NAP	SHEET NO.
CHECKED: TS	A0.2
APPROVED: TS	
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1 SITE PLAN - DIVERSEY HARBOR - DOCK G
 SCALE: 1/8" = 1'-0"



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- WESTREC TO PROVIDE FINAL LOCATION OF BARGE AT DOCK PER ADAAG STANDARDS FOR ACCESSIBLE BOATING FACILITIES

KEY NOTES:

- EXISTING 2" SANITARY LINE RUNS UNDERNEATH EXISTING DOCK. 2" CAM-LOCK FITTING PROVIDED AT DOCK BY WESTREC.
- GC TO PROVIDE BUILDING'S SANITARY CONNECTION TO EXISTING 2" CAM-LOCK FITTING UNDER DOCK.
- GC TO PROVIDE AND INSTALL NEW SECONDARY FEEDER FROM BUILDING TO CONNECTION AT DOCK. CONNECTION AT DOCK PROVIDED BY WESTREC
- GC TO PROVIDE BUILDING WATER CONNECTION TO EXISTING FITTING UNDER DOCK. EXISTING FITTING BY WESTREC.

5	07/18/2011	ISSUE FOR BID
4	07/01/2011	100% DESIGN SUBMITTAL
3	06/06/2011	90% DESIGN / ISSUE FOR PERMIT
2	02/04/2011	30% DESIGN SUBMITTAL
1	01/20/2011	SCHEMATIC DESIGN
NO	DATE	ISSUED FOR

PROJECT
WESTREC FLOATING WASHROOMS

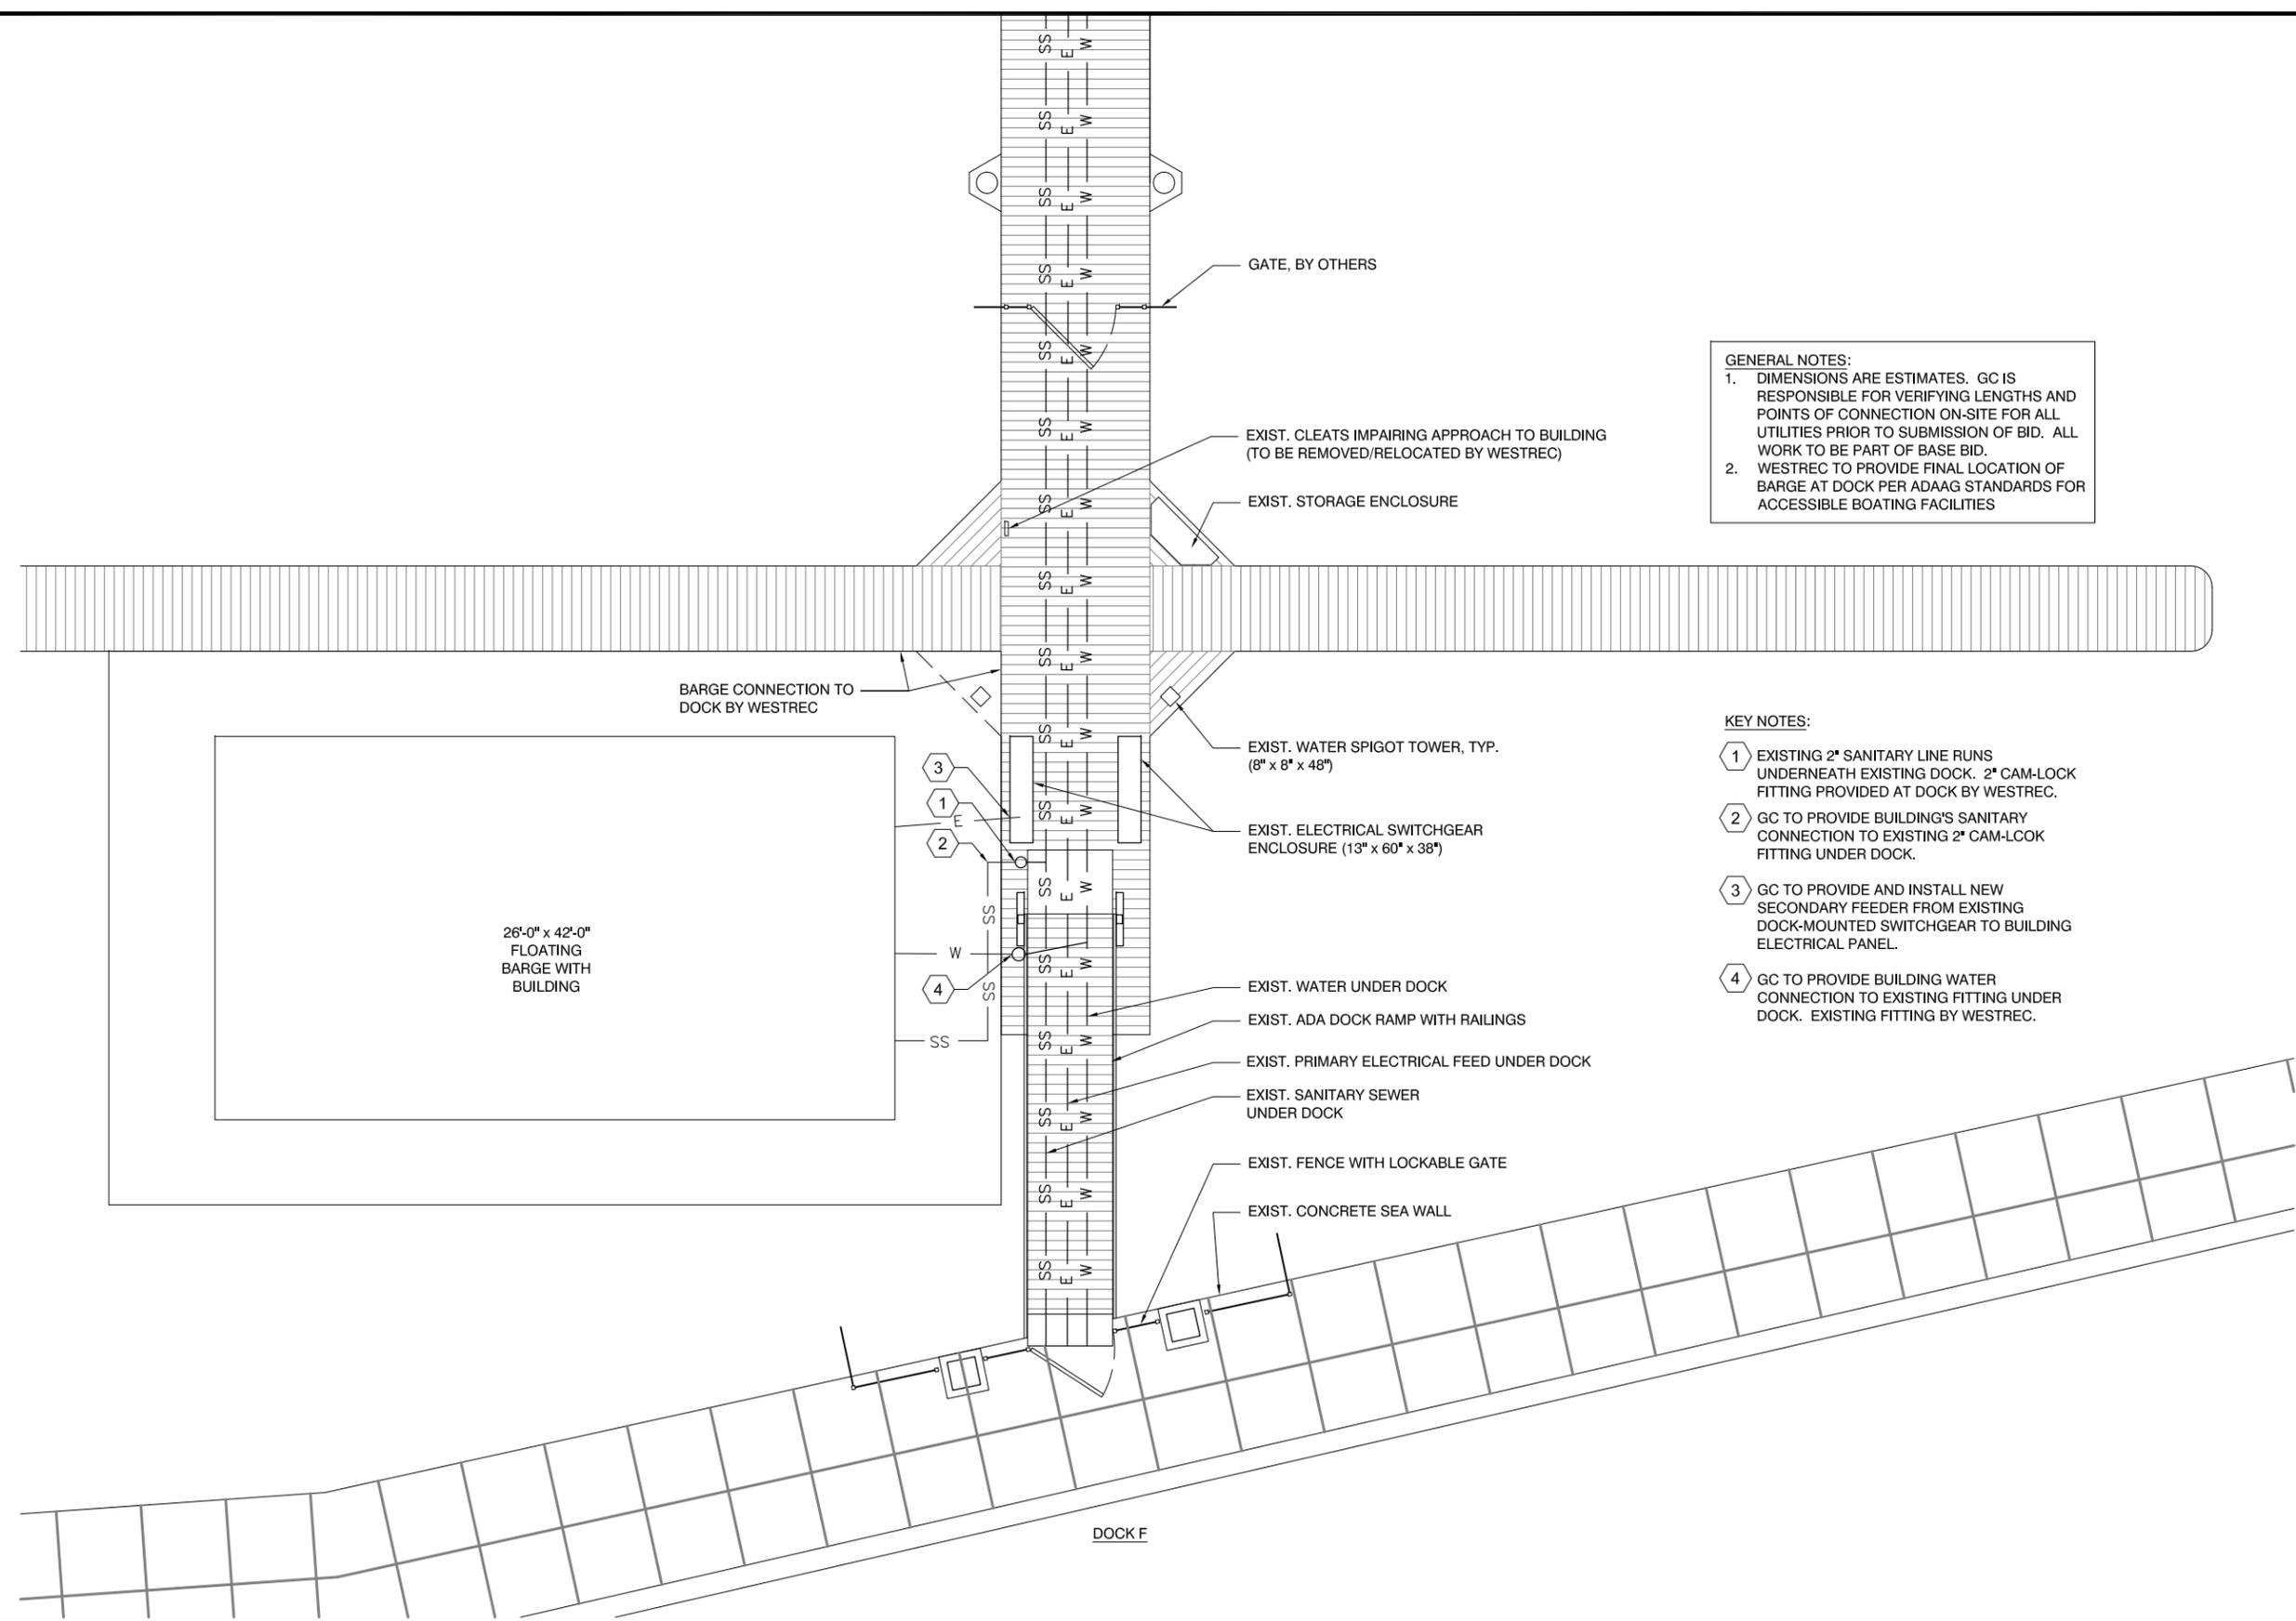
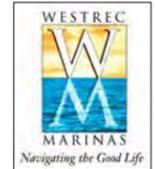
SHEET TITLE
SITE PLAN - JACKSON

DRAWN: NAP	SHEET NO.
CHECKED: TS	A0.3
APPROVED: TS	
JOB NO. 10.09.10	

1 SITE PLAN - JACKSON HARBOR - DOCK D
SCALE: 1/8" = 1'-0"



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GENERAL NOTES:

- DIMENSIONS ARE ESTIMATES. GC IS RESPONSIBLE FOR VERIFYING LENGTHS AND POINTS OF CONNECTION ON-SITE FOR ALL UTILITIES PRIOR TO SUBMISSION OF BID. ALL WORK TO BE PART OF BASE BID.
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PROJECT
WESTREC FLOATING WASHROOMS

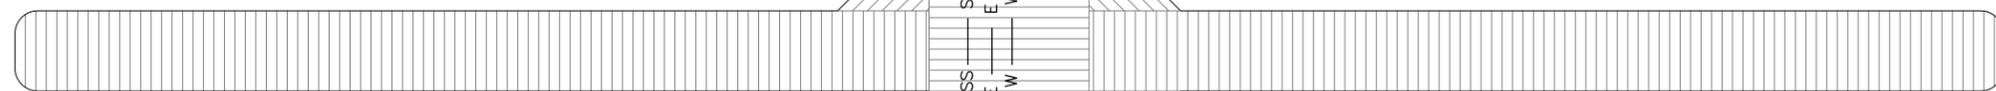
SHEET TITLE
SITE PLAN - BURNHAM HARBOR NORTH

DRAWN: NAP
CHECKED: TS
APPROVED: TS
JOB NO. 10.09.10

SHEET NO.
A0.4

1 SITE PLAN - BURNHAM HARBOR NORTH - DOCK F
SCALE: 1/8" = 1'-0"





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- GC TO PROVIDE BUILDING WATER CONNECTION TO EXISTING FITTING UNDER DOCK. EXISTING FITTING BY WESTREC.

EXIST. WATER SPIGOT TOWER, TYP. (8" x 8" x 48")

EXIST. ELECTRICAL SWITCHGEAR ENCLOSURE (13' x 60" x 38")

BARGE CONNECTION TO DOCK BY WESTREC

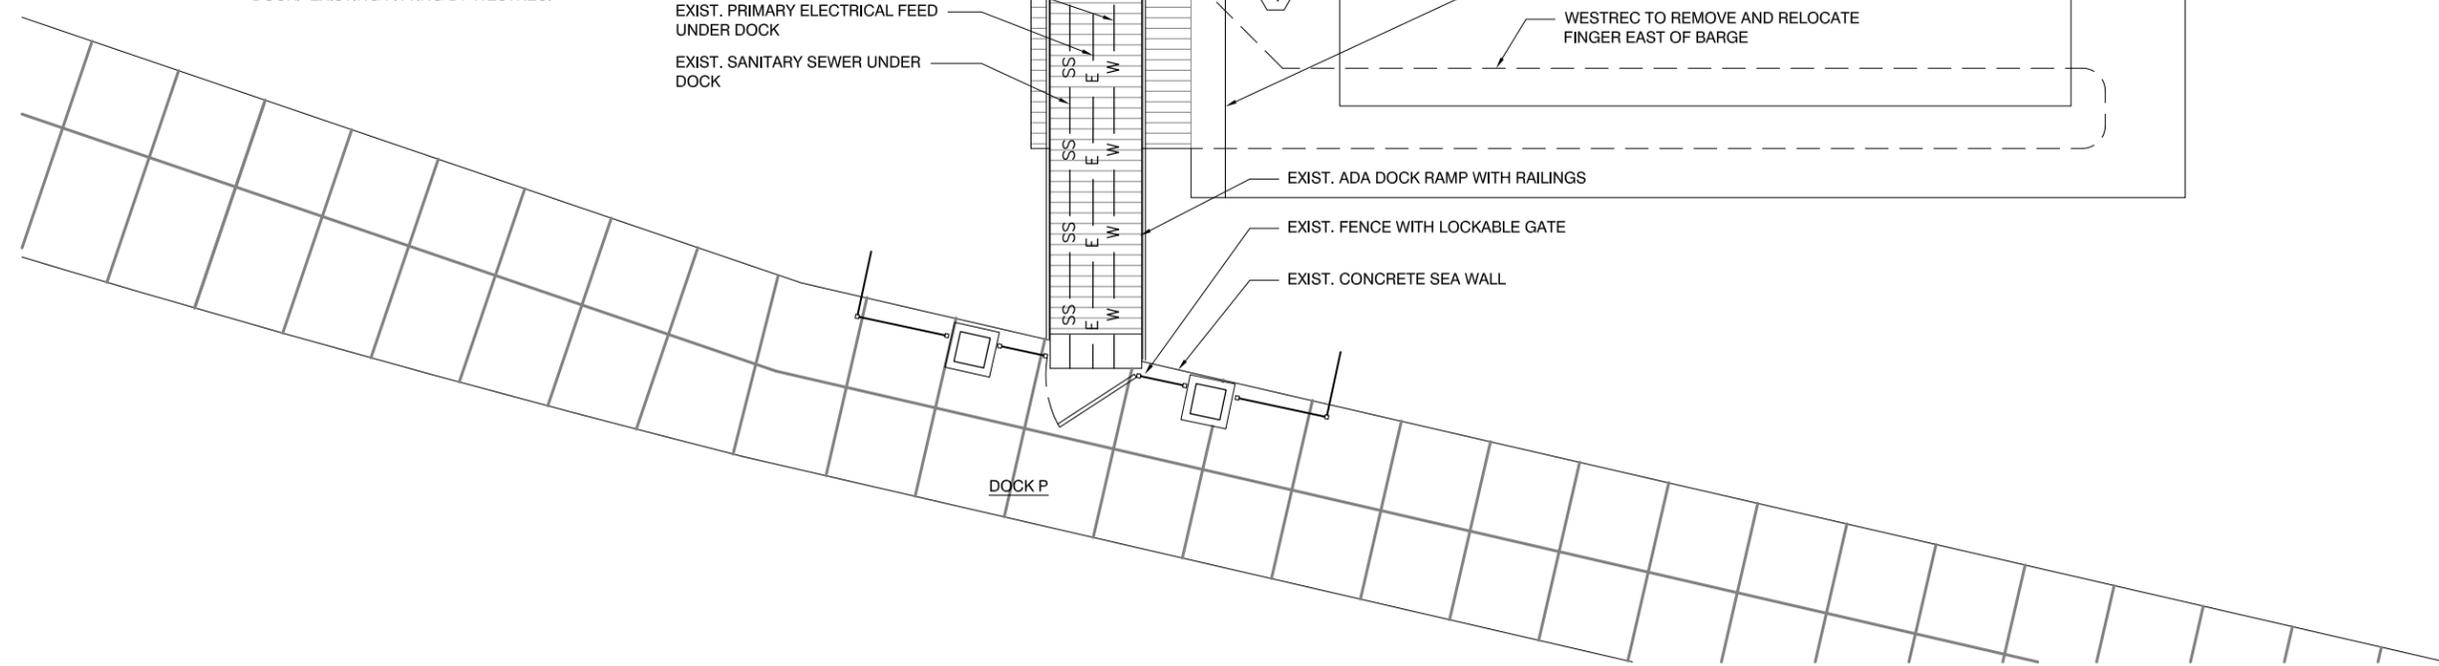
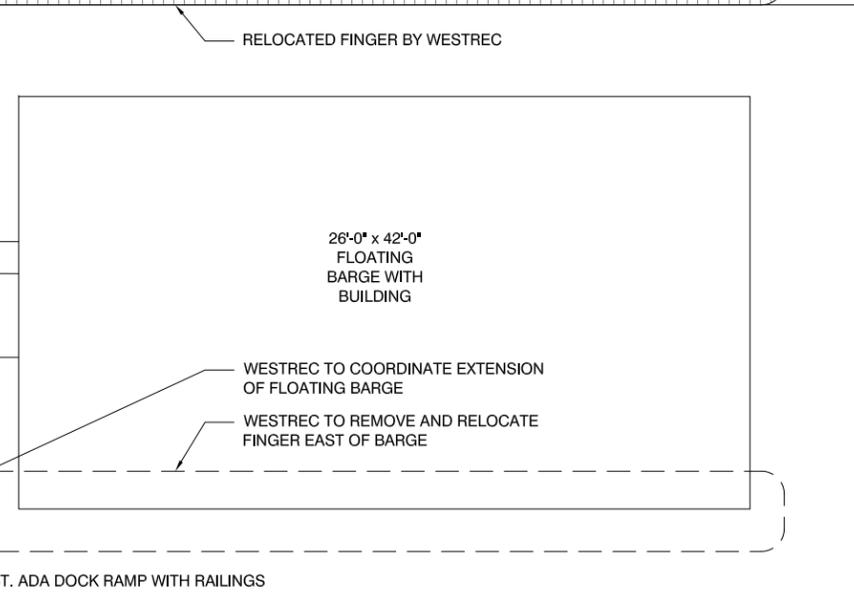
EXIST. WATER UNDER DOCK

EXIST. PRIMARY ELECTRICAL FEED UNDER DOCK

EXIST. SANITARY SEWER UNDER DOCK

GATE, BY OTHERS

EXIST. CLEATS IMPAIRING APPROACH TO BUILDING (TO BE REMOVED/RELOCATED BY WESTREC)



1 SITE PLAN - BURNHAM HARBOR SOUTH - DOCK P

SCALE: 1/8" = 1'-0"



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NO	DATE	ISSUED FOR

PROJECT
WESTREC FLOATING WASHROOMS

SHEET TITLE
SITE PLAN - BURNHAM SOUTH

DRAWN: NAP	SHEET NO.
CHECKED: TS	A0.5
APPROVED: TS	
JOB NO. 10.09.10	

ACCESSORY	MOUNTING
(B1) 42" HORIZONTAL GRAB BAR	MOUNT AT 3'-0" AFF TO CL OF BAR
(B2) 36" HORIZONTAL GRAB BAR	MOUNT AT 3'-0" AFF TO CL OF BAR
(B3) 42" OR 48" HORIZ. GRAB BAR	MOUNT AT 3'-0" AFF TO CL OF BAR
(C1) BABY CHANGING STATION	MOUNT AT 4'-0" AFF TO HANDLE
(D1) TOILET PAPER DISPENSOR	MOUNT AT 2'-0" AFF TO PAPER OUTLET
(D2) TOILET PAPER DISPENSOR	MOUNT AT 11'-9" AFF TO PAPER OUTLET MIN. 1 1/2" CLEAR OF GRAB BAR
(H1) ELECTRIC HAND DRYER	MOUNT AT 4'-0" AFF TO CONTROLS
(H2) ELECTRIC HAND DRYER	MOUNT AT 3'-4" AFF TO CONTROLS
(K1) DOUBLE TOWEL HOOK	MOUNT AT 4'-0" AFF
(M) MIRROR W/ SHELF	MOUNT AT 3'-4" AFF TO BOTTOM OF REFLECTIVE SURFACE
(T1) ADA SHOWER SEAT	MOUNT AT 1'-6" AFF TO TOP OF SEAT

ACCESSORY	MOUNTING
(V1) 18" VERTICAL GRAB BAR	MOUNT 4" ABOVE HORIZ. BAR
(P1) SOAP DISPENSOR	MOUNT AT 3'-9" AFF TO CONTROLS
(S1) 18" SHELF WITH HOOKS	MOUNT AT 4'-0" AFF TO HOOKS
(S2) 18" SHELF WITH HOOKS	MOUNT AT 3'-11" AFF TO SHELF
(W1) TYPICAL WATER CLOSET	MOUNT SEAT HEIGHT AT 1'-3" AFF CENTERLINE OF TOILET 1'-6"
(W2) ADULT ADA WATER CLOSET	MOUNT SEAT HEIGHT AT 1'-6" AFF CENTERLINE OF TOILET 1'-6"
(L1) TYPICAL LAVATORY	MOUNT AT 2'-7" AFF RIM HEIGHT
(L2) ADULT ADA LAVATORY	MOUNT AT 2'-10" AFF MAX. RIM HEIGHT. 2'-5" MIN. KNEE SPACE.
(R1) CURTAIN ROD OR 1 1/4" O.D. CHROME-PLATED PIPE W/ WALL MOUNTS	MOUNT AT 6'-6" AFF TO CENTERLINE OF ROD

GENERAL NOTES

- MEP COMPONENTS INCLUDING, BUT NOT LIMITED TO, CONDUIT AND PIPES ARE SHOWN ON ARCHITECTURAL PLANS FOR REFERENCE ONLY. NOT ALL PENETRATIONS AND MEP COMPONENTS ARE SHOWN. CONTRACTOR TO COORDINATE AND ADJUST CHASES AND COLUMN ENCLOSURES AS REQUIRED TO FIT MEP COMPONENTS UPON ARCHITECT'S APPROVAL.
- FOR ELECTRICAL COMPONENTS LOCATED ON EXTERIOR WALLS, ROUTE CONDUIT HORIZONTALLY FROM THE PLUMBING CHASE THROUGH ADJACENT WALLS. DO NOT ROUTE CONDUIT FROM OVERHEAD BETWEEN THE PERFORATED PANELS.
- SLOPE CONCRETE TO DRAIN MIN. 1/4" PER FOOT, TYPICAL ALL ROOMS. SEE RESTROOM 101 FOR TYPICAL.
- GO TO COORDINATE CLEARANCES OF COIN LAUNDRY UNIT

Room No.	Room Name	Floor Finish	Base	Wall Finish	Ceiling Finish
101	Rest Room	CT-2	CT-1	CT-1	WOOD
102	Rest Room	CT-2	CT-1	CT-1	WOOD
103	Rest Room	CT-2	CT-1	CT-1	WOOD
104	Electrical	CONC	VINYL	GYP BD PT-1	GYP BD PT-1
105	Rest Room	CT-2	CT-1	CT-1	WOOD
106	Rest Room	CT-2	CT-1	CT-1	WOOD
107	ADA Rest Room	CT-2	CT-1	CT-1	WOOD
108	Plumbing Chase	N/A	N/A	N/A	N/A
109	Utility	CONC	VINYL	GYP BD PT-1	GYP BD PT-1
110	Office	CT-3	WOOD	GYP BD PT-1	WOOD
111	Claset	CT-3	WOOD	GYP BD PT-1	GYP BD PT-1

Symbol	Material	Description
Floor		
CT-2	Ceramic Tile	2"x2" tile; Basis of Design: Daltile #D202 "Uptown Taupe Speckle"
CT-3	Ceramic Tile	6.5"x20" tile; Basis of Design: Daltile #CN94 "Eastside Brown"
CONC	Concrete	Smooth finish
Wall		
CT-1	Ceramic Tile	2"x2" tile; Basis of Design: Daltile #D161 "Urban Putty"
PT-1	Paint	Basis of Design: Benjamin Moore "White Dove"
PT-2	Paint	Basis of Design: Benjamin Moore #2125-10 "Black Panther"
Base		
WOOD	Wood	4" Cedar
VINYL	Vinyl Base	4" base; Basis of Design: Armstrong #15 "Zinc"
Exterior		
SIDING	Fiber Cement Bd	4" exposure; Basis of Design: HardiePlank "Cobble Stone"
ROOF	Metal	Basis of Design: Peterson Aluminum color "Silver"

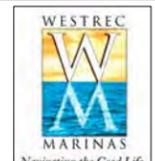
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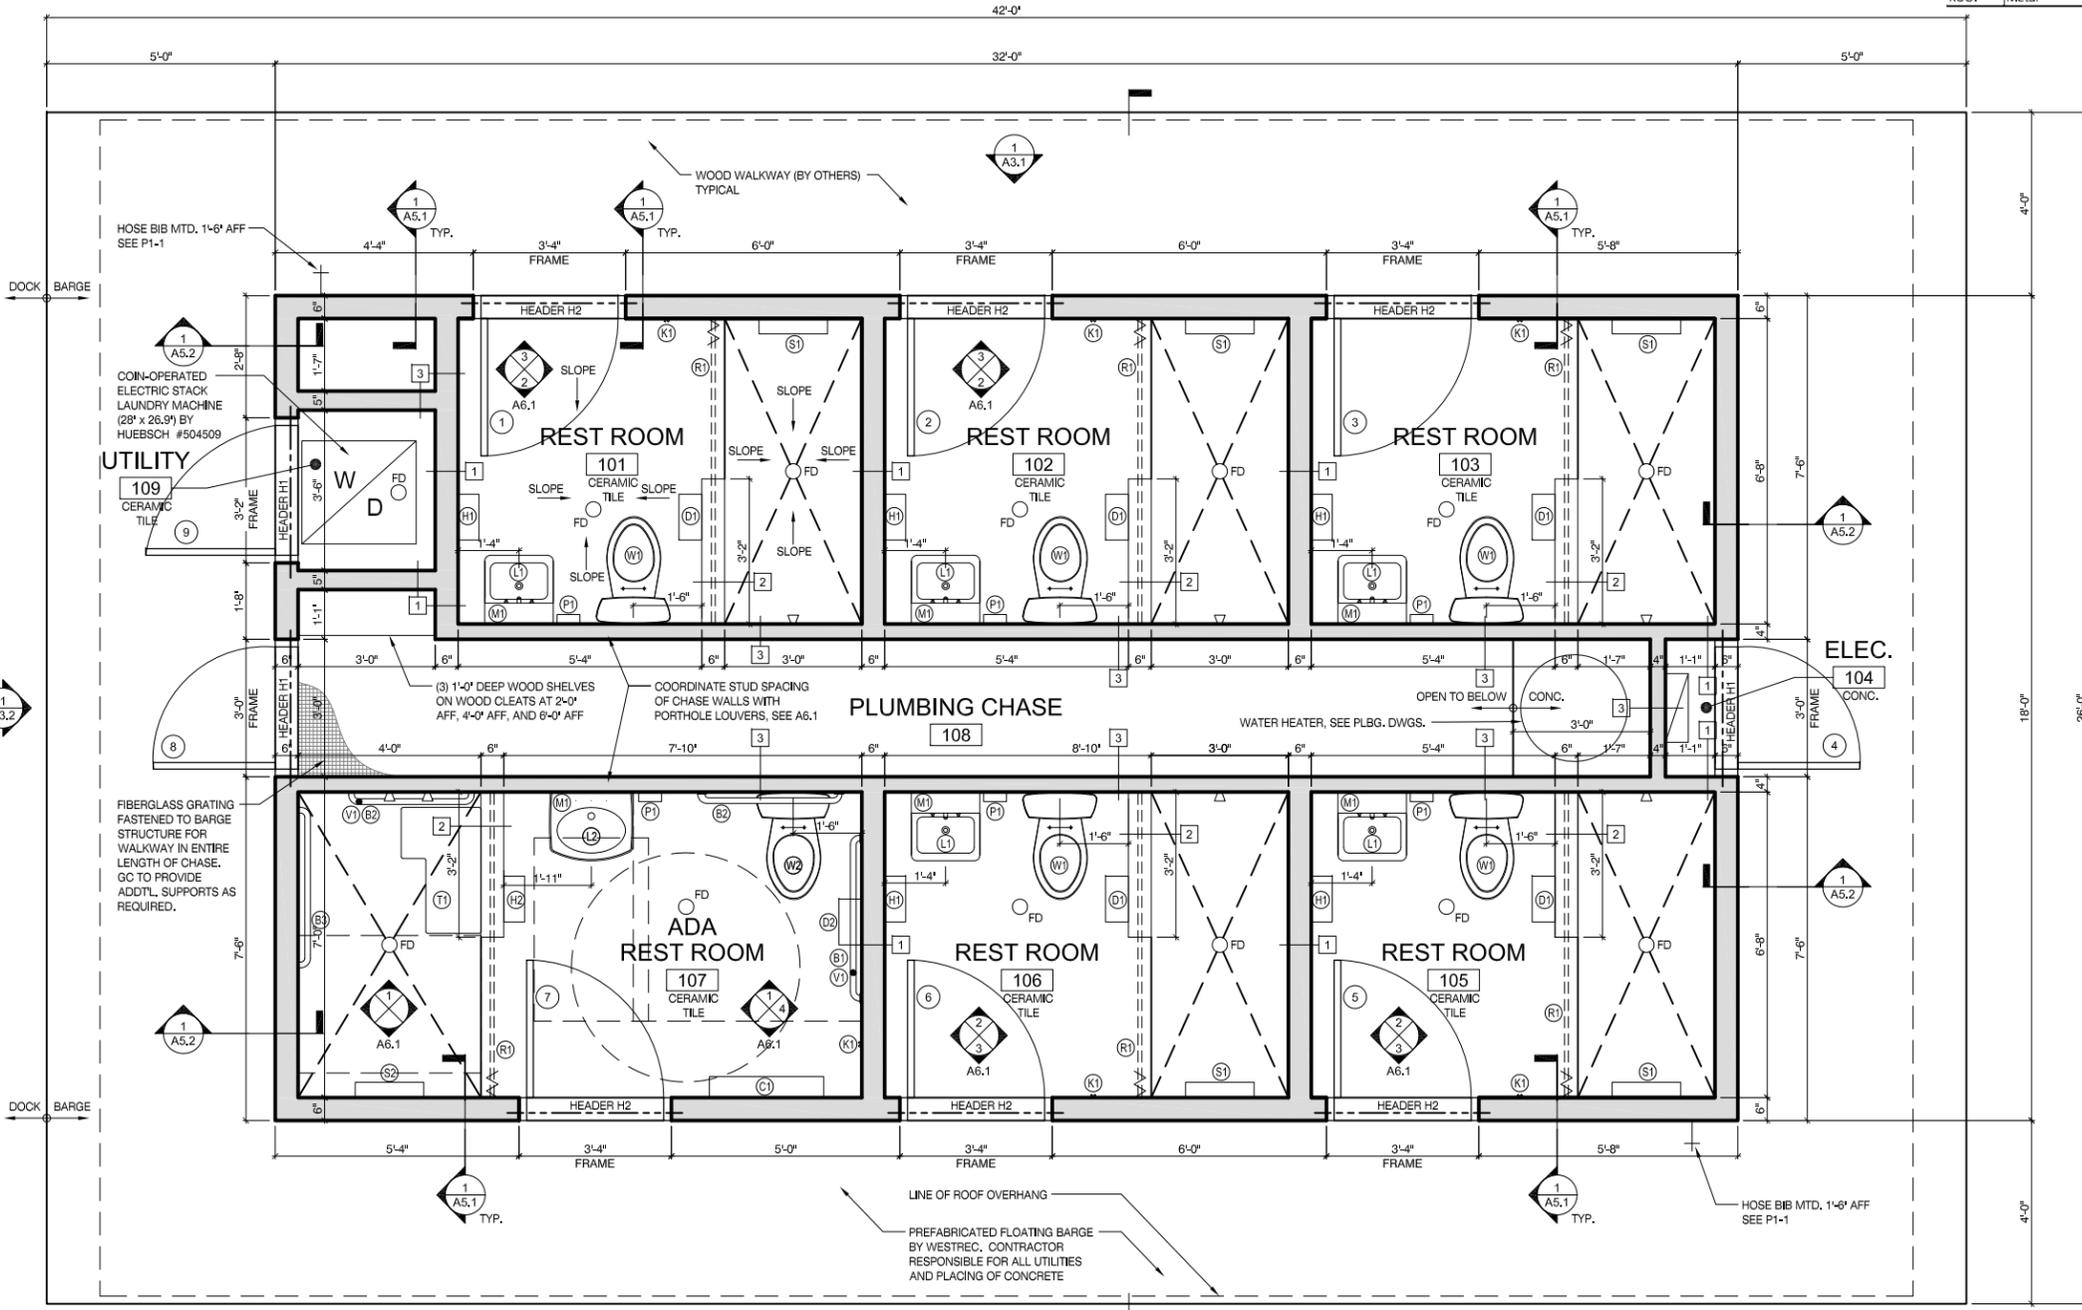
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WESTREC
MARINAS
Navigating the Good Life



DESIGN LOADS FOR ROOF TRUSS:

- SNOW LOADS:**
TYPICAL ROOF 25 PSF
- WIND LOADS:**
MAIN WIND RESISTING SYSTEM 30 PSF
UPLIFT ON HANGERS 40 PSF
- MAXIMUM TRUSS SPACING TO BE 2'-0" O.C.

COLD FORMED (LIGHT GAUGE) STRUCTURAL STEEL

- CONFORM TO AISI "SPECIFICATIONS FOR THE DESIGN OF COLD-FORMED STEEL STRUCTURAL MEMBERS" LATEST EDITION.
- FORM ALL STRUCTURAL MEMBERS FROM CORROSION-RESISTANT STEEL CORRESPONDING TO ASTM A653-94 YIELD STRENGTH: 33 KSI
- ZINC COAT ALL STRUCTURAL MEMBERS PER ASTM A294 (G90 COATING). TOUCH UP ALL WELDS WITH ZINC RICH PAINT.
- THE CONTRACTOR SHALL SUBMIT DETAILED, ENGINEERED, COORDINATED, AND CHECKED SHOP DRAWINGS PRIOR TO FABRICATION, STAMPED BY A STRUCTURAL ENGINEER LICENSED IN THE STATE OF ILLINOIS.
- ALL FRAMING COMPONENTS MUST BE CUT SQUARELY FOR ATTACHMENT TO PERPENDICULAR MEMBERS OR AS REQUIRED FOR AN ANGULAR FIT AGAINST ABUTTING MEMBERS. ALL MEMBERS SHALL BE HELD POSITIVELY IN PLACE UNTIL PROPERLY FASTENED.
- FASTENING OF COMPONENTS SHALL BE SELF-DRILLING SCREWS OR BY WELDING AS INDICATED. DO NOT WIRE TIE COMPONENTS.
- ALL WELDING WORK SHALL CONFORM TO A.W.S. D.1.3 "STRUCTURAL WELDING CODE - SHEET STEEL" LATEST EDITION. ALL WELDING SHALL BE PERFORMED BY A.W.S. CERTIFIED WELDERS QUALIFIED IN ACCORDANCE WITH SECTION 6 OF THE A.W.S. D.1.3.
- PROVIDE TEMPORARY BRACING UNTIL ERECTION IS COMPLETE.
- COMPLETE, UNIFORM AND LEVEL BEARING SUPPORT MUST BE PROVIDED FOR STUD RUNNER TRACKS. ATTACH STUD TO BOTH FLANGES OF THE UPPER AND LOWER RUNNER TRACKS.
- AXIALLY LOADED STUDS SHALL HAVE FULL BEARING AGAINST INSIDE TRACK WEB PRIOR TO STUD AND TRACK ATTACHMENT.
- PROVIDE HORIZONTAL STRAP AND BLOCKING OR COLD-ROLLED CHANNEL BRACING FOR ALL STUDS, PER MANUFACTURER RECOMMENDATIONS.

PLYWOOD

- TO BE CDX EXTERIOR GRADE

INTERIOR WALLS

STUDS AT 16" O.C. 362S162-33 (20 GA.)
RUNNERS 362T150-33 (20 GA.)

3/8" DIA. S.S. EXP. ANCHOR WITH NUTS AND WASHERS - 48" O.C., EMBED 3" INTO CONCRETE

EXTERIOR WALLS

- SEE FRAMING ELEVATIONS ON A3.1
- SEE DETAIL 3 ON A5.1 FOR TYPICAL EXTERIOR WALL FRAMING

HEADERS

- H1 DBL. C-CHANNEL HEADER - SEE 2/A5.2 (2) 60S162-54 WITH WEB STIFFENERS AND SUPPORTS AND CHANNEL TRACK TOP AND BOTTOM
- H2 TRUSS HEADER - SEE 3/A3.1

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PROJECT

WESTREC FLOATING WASHROOMS

SHEET TITLE

FLOOR PLAN

DRAWN: NAP	SHEET NO.
CHECKED: TS	A1.1
APPROVED: TS	
JOB NO. 10.09.10	

1 FLOOR PLAN

SCALE: 1/4" = 1'-0"



ACCESSORY	MOUNTING
(B1) 42" HORIZONTAL GRAB BAR	MOUNT AT 3'-0" AFF TO CL OF BAR
(B2) 36" HORIZONTAL GRAB BAR	MOUNT AT 3'-0" AFF TO CL OF BAR
(B3) 42" OR 48" HORIZ. GRAB BAR	MOUNT AT 3'-0" AFF TO CL OF BAR
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ACCESSORY	MOUNTING
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109	Utility	CONC	VINYL	GYP BD PT-1	GYP BD PT-1
110	Office	CT-3	WOOD	GYP BD PT-1	WOOD
111	Closet	CT-3	WOOD	GYP BD PT-1	GYP BD PT-1

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Exterior		
SIDING	Fiber Cement Bd	4" exposure; Basis of Design: HardiePlank "Cobble Stone"
ROOF	Metal	Basis of Design: Peterson Aluminum color "Silver"

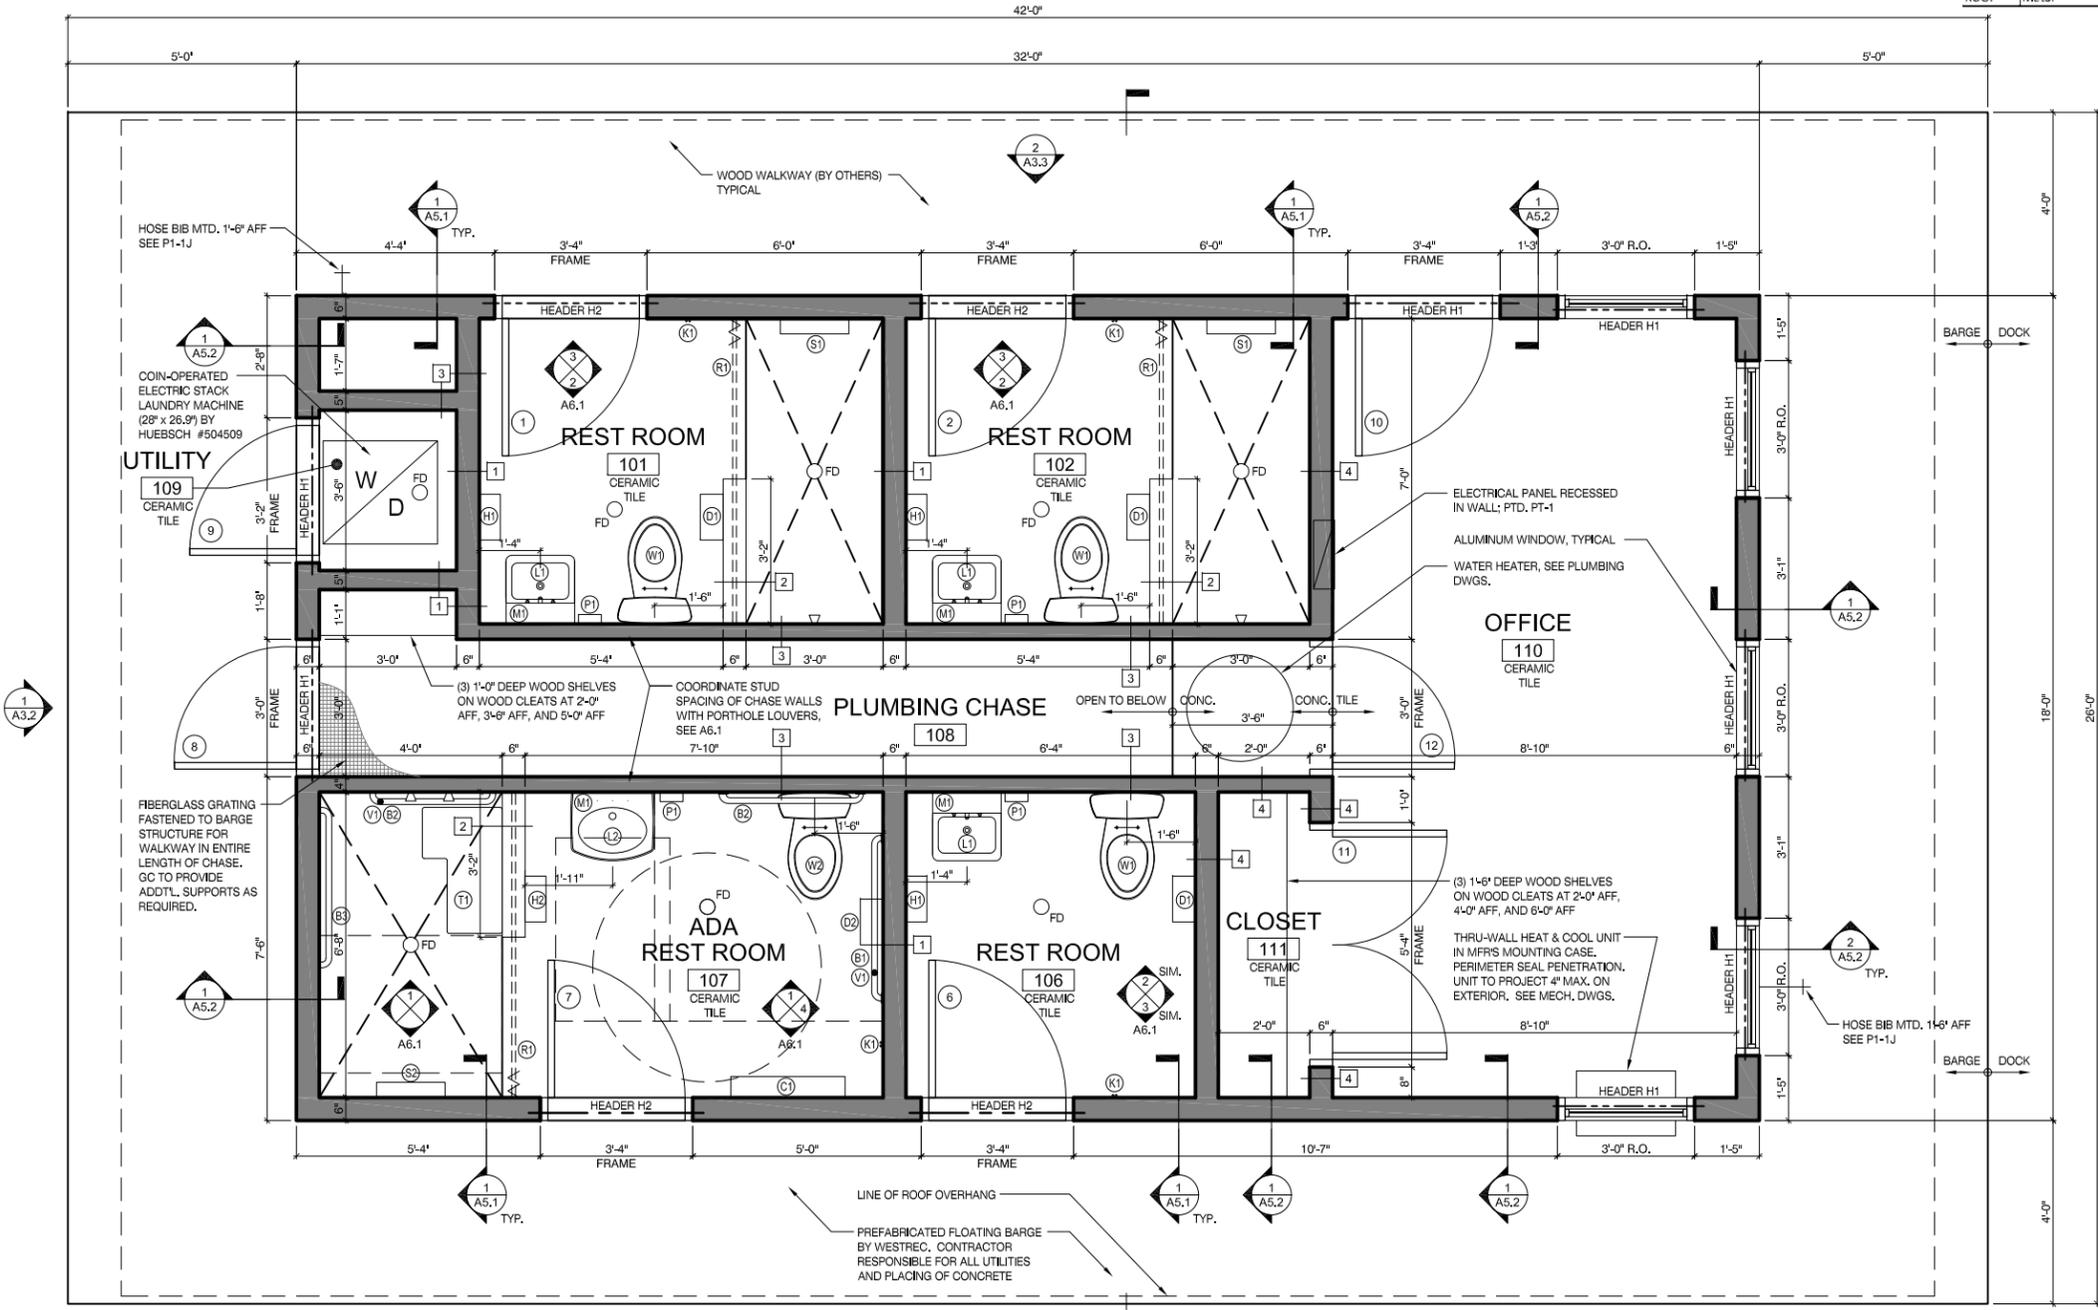
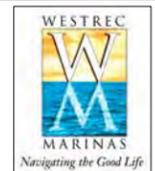
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UPLIFT ON HANGERS 40 PSF
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RUNNERS 362T150-33 (20 GA.)

3/8" DIA. S.S. EXP. ANCHOR WITH NUTS AND WASHERS - 48" O.C., EMBED 3" INTO CONCRETE

EXTERIOR WALLS

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- SEE DETAIL 3 ON A5.1 FOR TYPICAL EXTERIOR WALL FRAMING

HEADERS

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(2) 600S162-54 WITH WEB STIFFENERS AND SUPPORTS AND CHANNEL TRACK TOP AND BOTTOM

H2 TRUSS HEADER - SEE 3/A3.1

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PROJECT

WESTREC FLOATING WASHROOMS

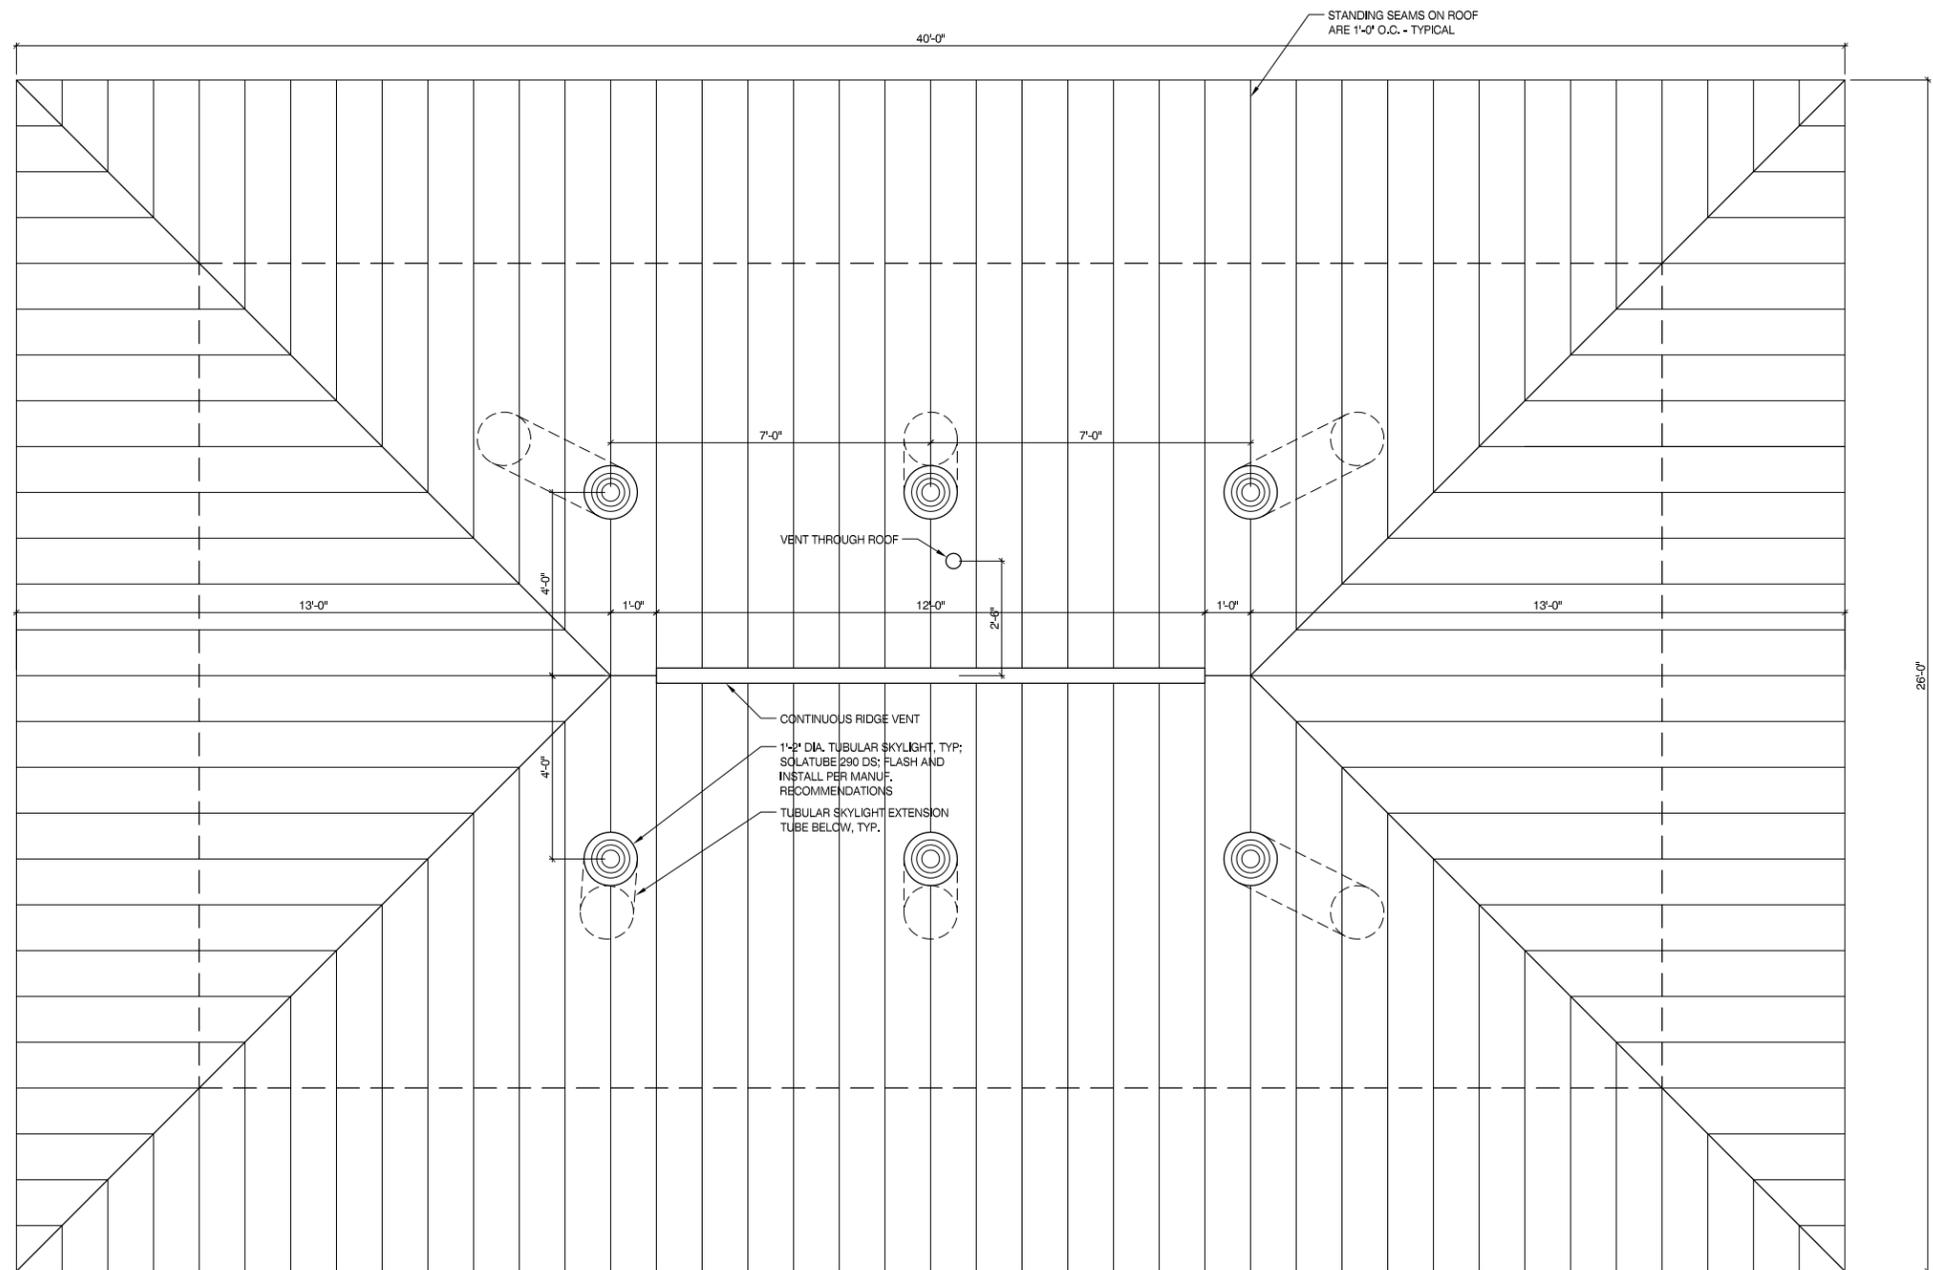
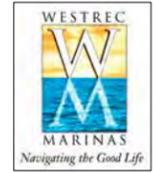
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DRAWN: NAP	SHEET NO.
CHECKED: TS	A1.1 J
APPROVED: TS	
JOB NO. 10.09.10	

1 FLOOR PLAN (JACKSON HARBOR)

SCALE: 1/4" = 1'-0"



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1 ROOF PLAN
SCALE: 1/4" = 1'-0"



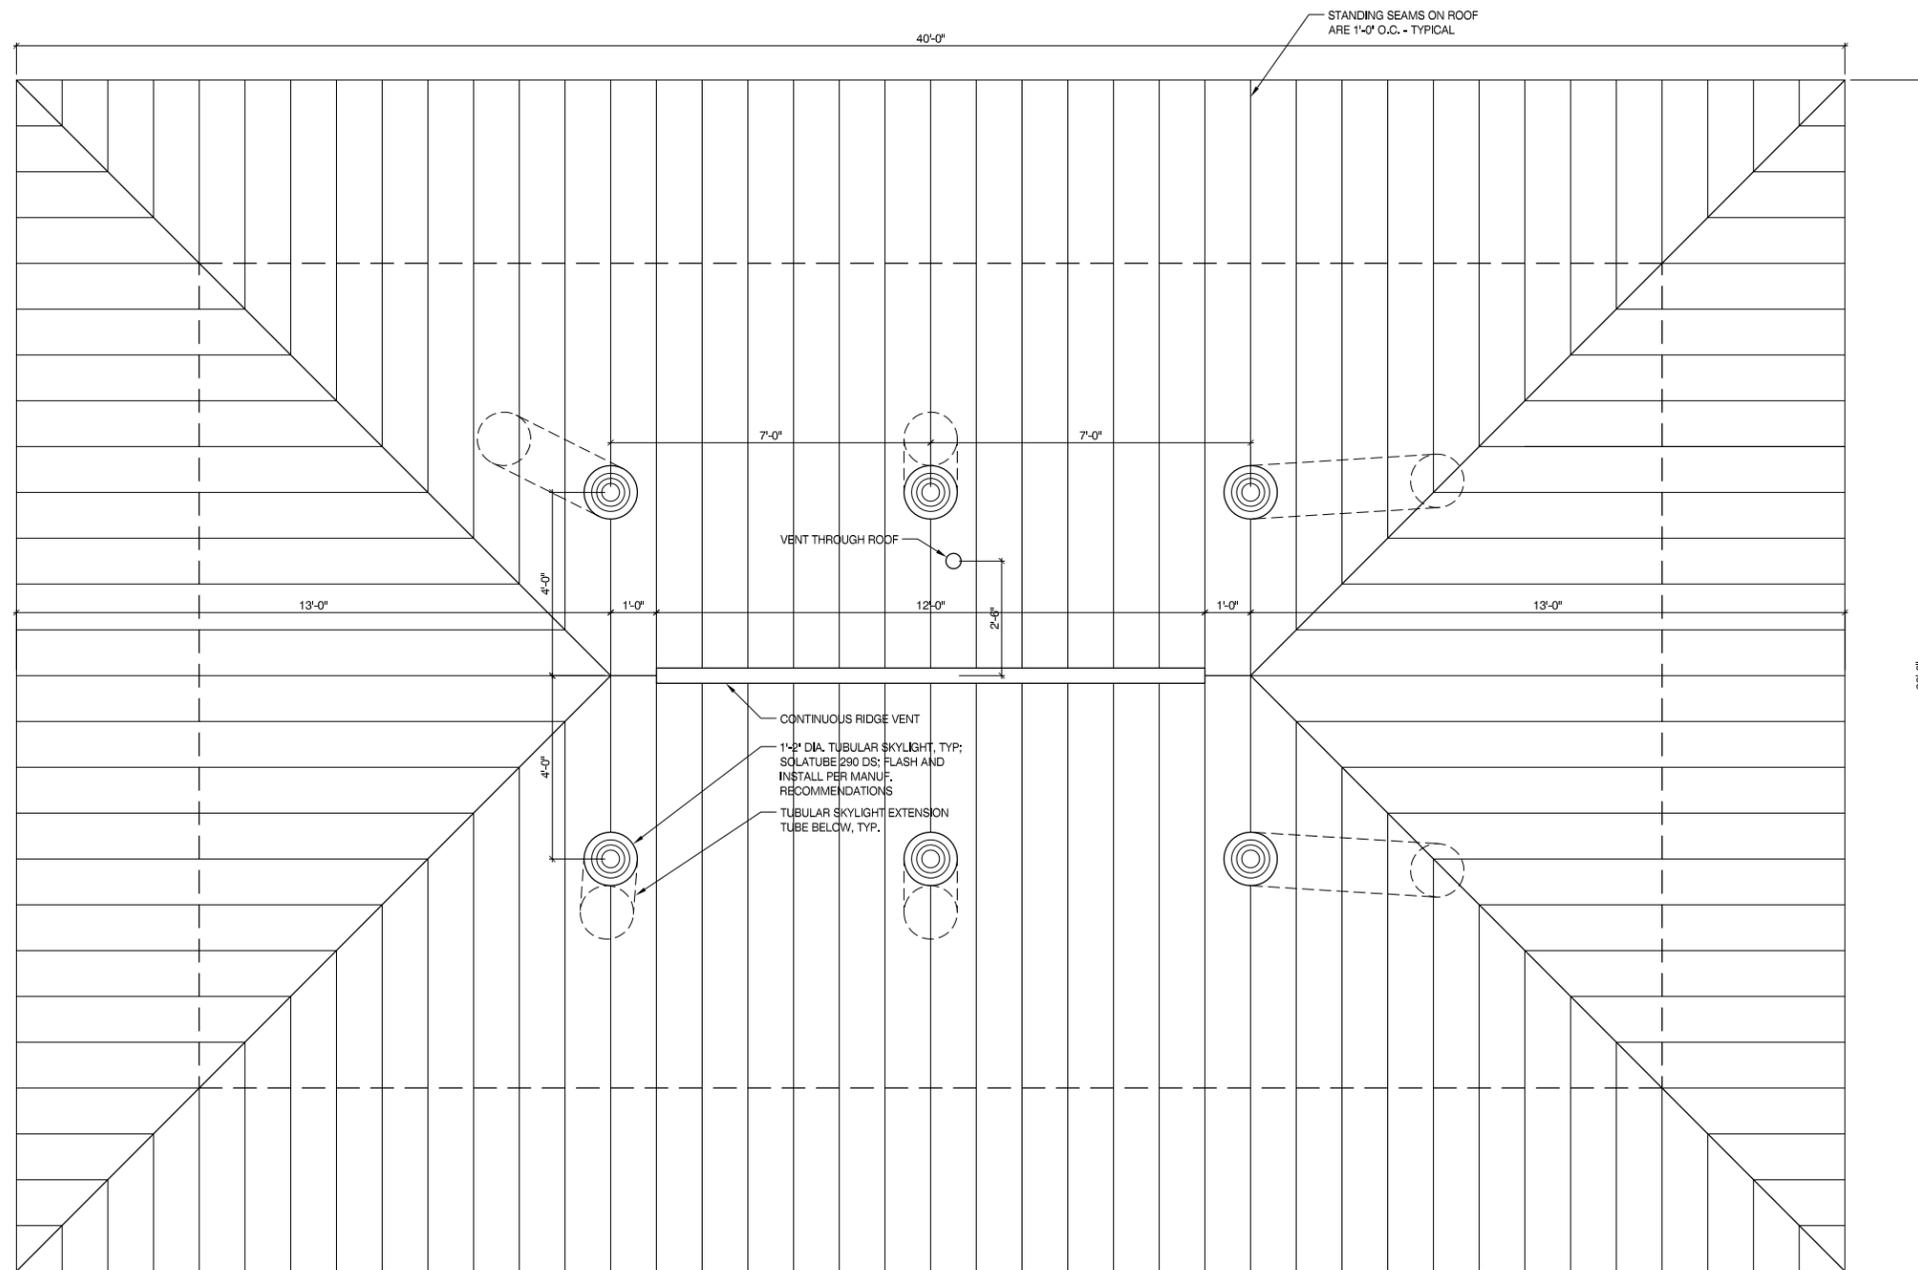
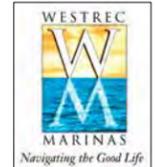
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4	07/01/2011	100% DESIGN SUBMITTAL
3	06/06/2011	90% DESIGN / ISSUE FOR PERMIT
2	02/04/2011	30% DESIGN SUBMITTAL
1	01/20/2011	SCHEMATIC DESIGN
NO	DATE	ISSUED FOR

PROJECT
WESTREC FLOATING WASHROOMS

SHEET TITLE
ROOF PLAN

DRAWN: NAP	SHEET NO. A1.2
CHECKED: TS	
APPROVED: TS	
JOB NO. 10.09.10	

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1 ROOF PLAN (JACKSON HARBOR)

SCALE: 1/4" = 1'-0"



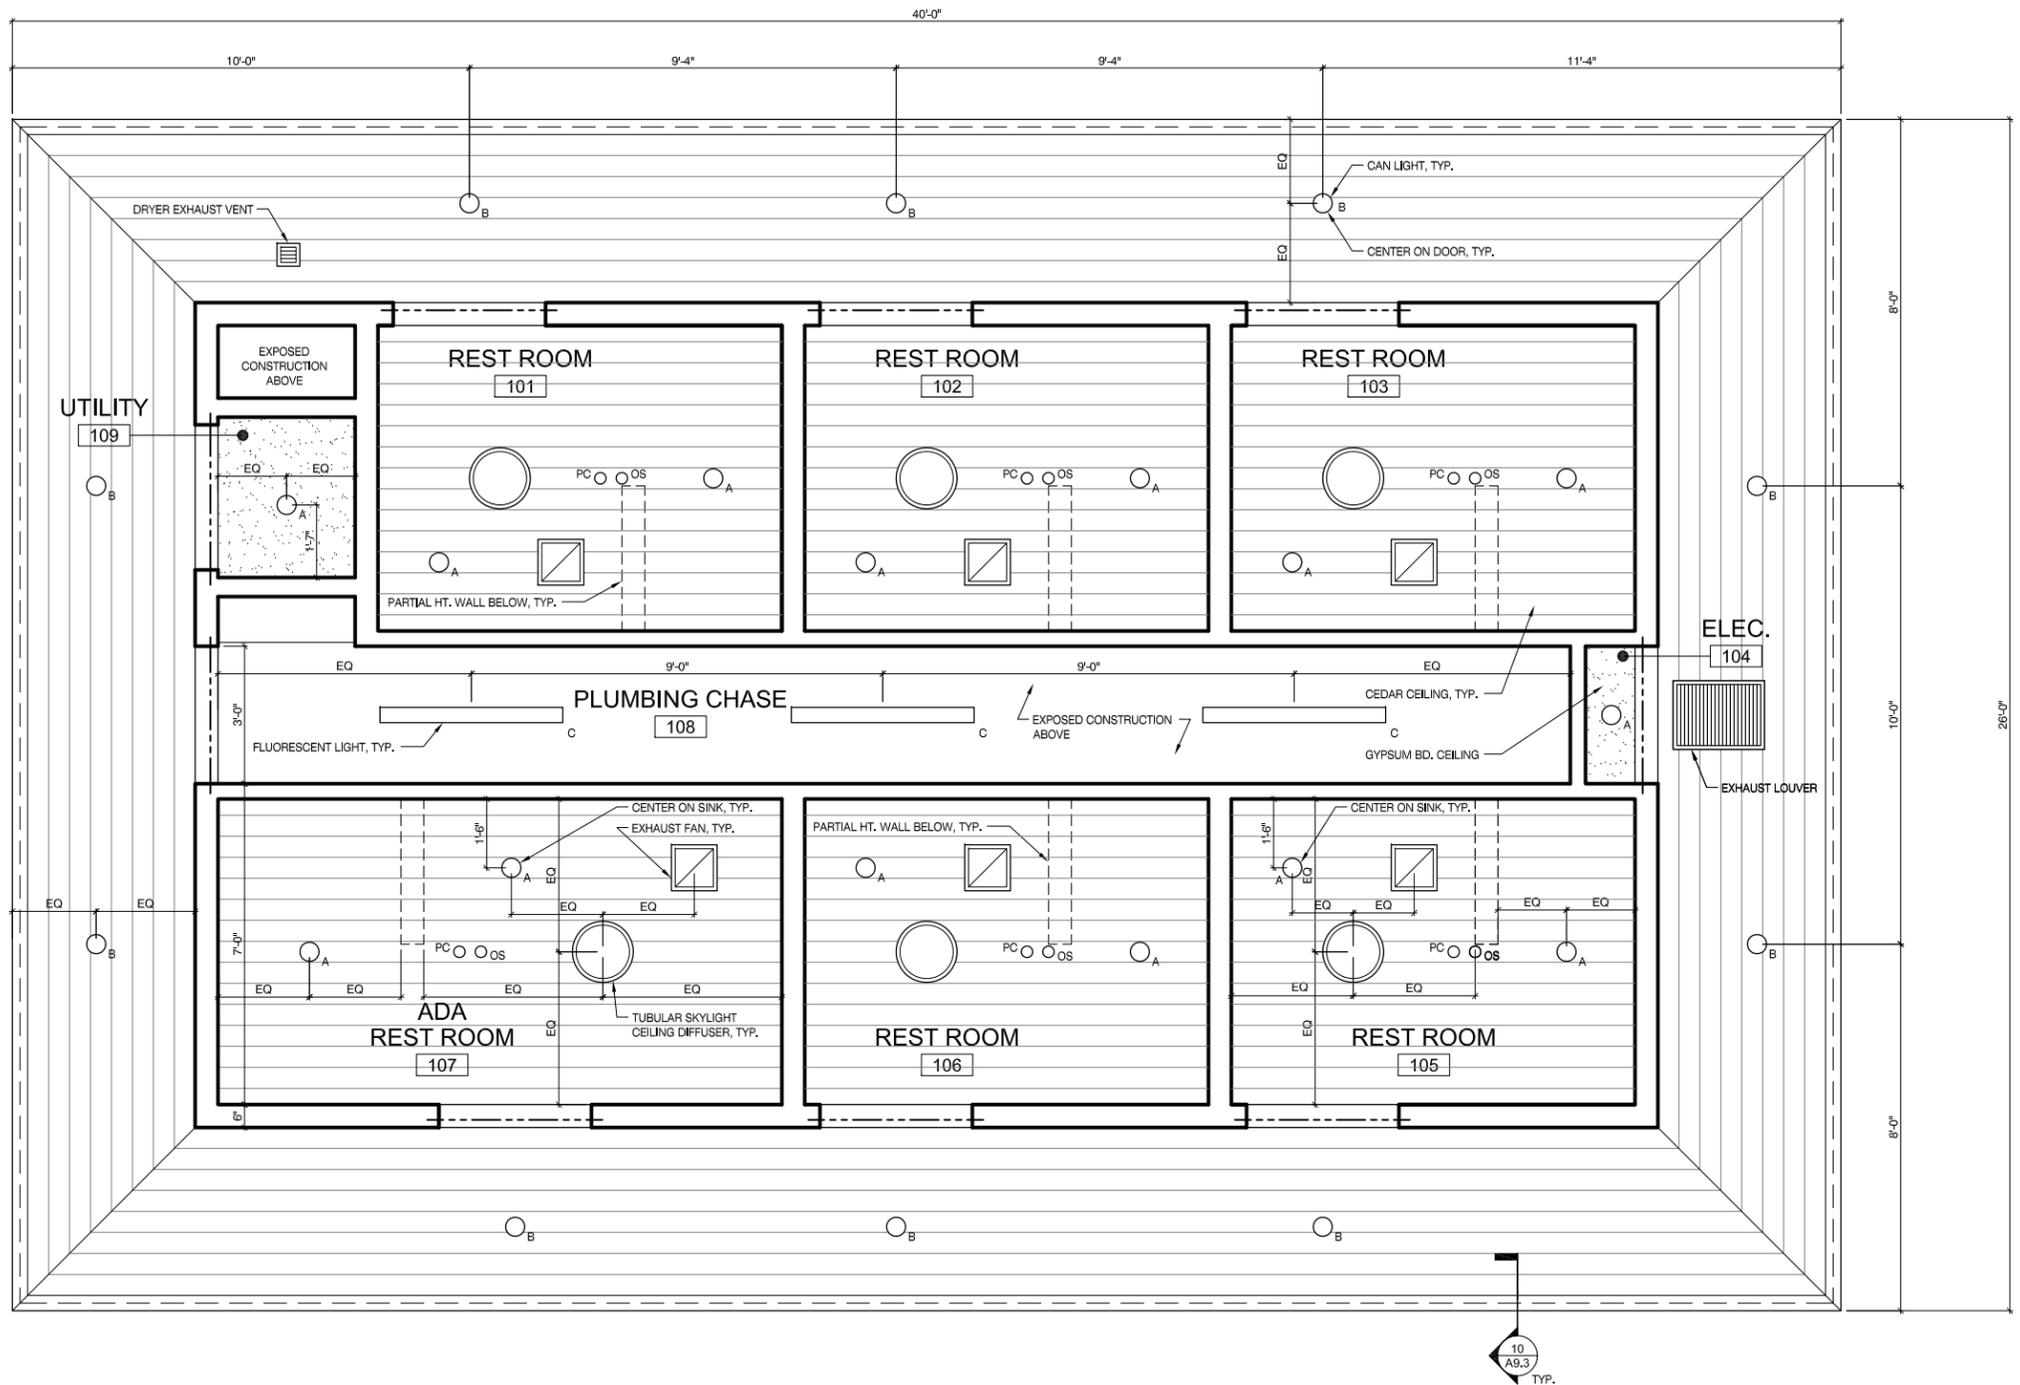
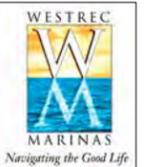
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1	01/20/2011	SCHEMATIC DESIGN
NO	DATE	ISSUED FOR

PROJECT
WESTREC FLOATING WASHROOMS

SHEET TITLE
ROOF PLAN (JACKSON)

DRAWN: NAP	SHEET NO.
CHECKED: TS	A1.2 J
APPROVED: TS	
JOB NO. 10.09.10	

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1 REFLECTED CEILING PLAN
SCALE: 1/4" = 1'-0"



- GENERAL NOTES**
- ALL CEILING FIXTURES AND DEVICES TO BE CENTERED IN CEILING AND ALIGNED WITH ARCHITECTURAL ELEMENTS UNLESS NOTED OTHERWISE
 - RECESSED FIXTURES IN SHOWERS TO BE VAPOR PROOF
 - PROVIDE ACCESS PANELS IN CEILING AND WALLS AS REQUIRED. SEE MECHANICAL DRAWINGS AND SPECS FOR MORE INFORMATION. OBTAIN APPROVAL OF LOCATIONS AND COLORS WITH OWNER/ARCHITECT AT ACCESS PANEL PRE-INSTALLATION CONFERENCE.

LEGEND	
	CEDAR CEILING
	GYPSON BOARD CEILING
PC	PHOTO CELL
OS	OCCUPANCY SENSOR

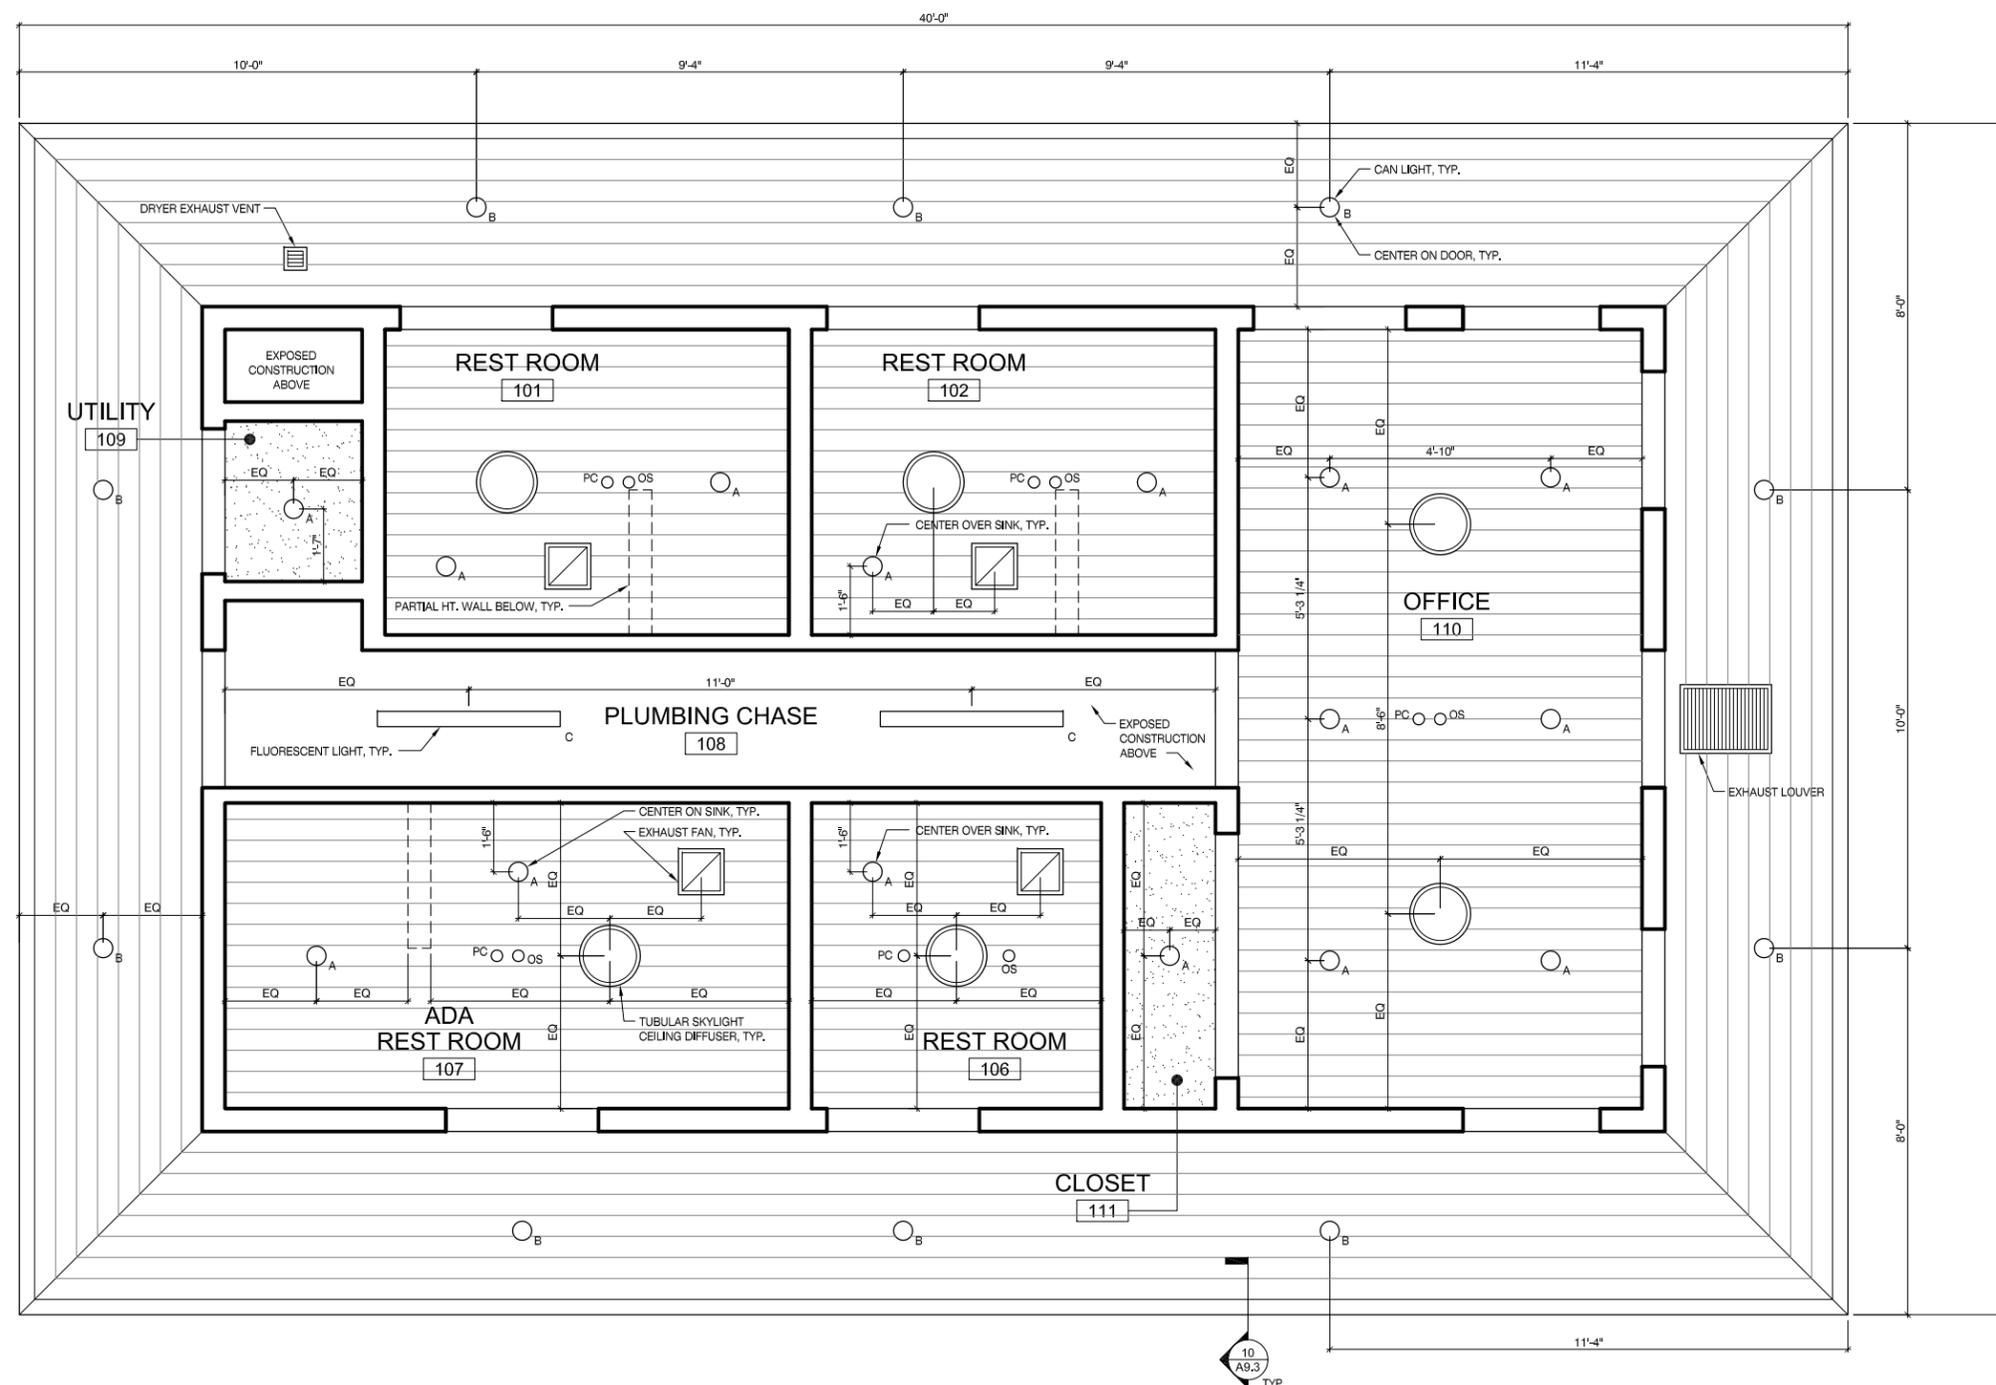
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2	02/04/2011	30% DESIGN SUBMITTAL
1	01/20/2011	SCHEMATIC DESIGN

PROJECT
WESTREC FLOATING WASHROOMS

SHEET TITLE
REFLECTED CEILING PLAN

DRAWN: NAP	SHEET NO.
CHECKED: TS	A2.1
APPROVED: TS	
JOB NO. 10.09.10	

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1 REFLECTED CEILING PLAN (JACKSON HARBOR)
SCALE: 1/4" = 1'-0"



- GENERAL NOTES**
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 - RECESSED FIXTURES IN SHOWERS TO BE VAPOR PROOF
 - PROVIDE ACCESS PANELS IN CEILING AND WALLS AS REQUIRED. SEE MECHANICAL DRAWINGS AND SPECS FOR MORE INFORMATION. OBTAIN APPROVAL OF LOCATIONS AND COLORS WITH OWNER/ARCHITECT AT ACCESS PANEL PRE-INSTALLATION CONFERENCE.

LEGEND	
	CEDAR CEILING
	GYPSUM BOARD CEILING
PC	PHOTO CELL
OS	OCCUPANCY SENSOR

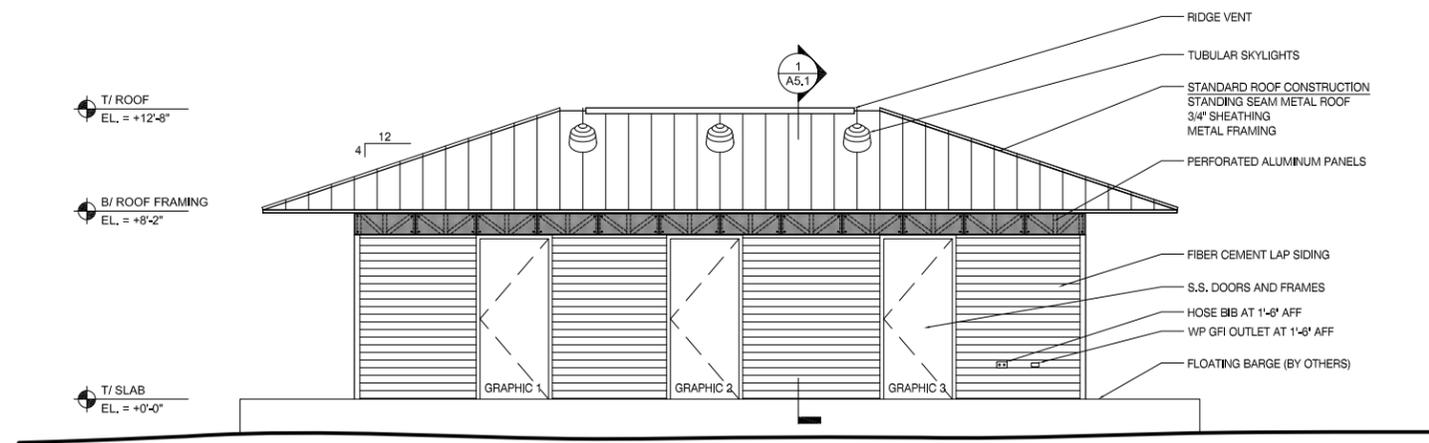
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1	01/20/2011	SCHEMATIC DESIGN

PROJECT
WESTREC FLOATING WASHROOMS

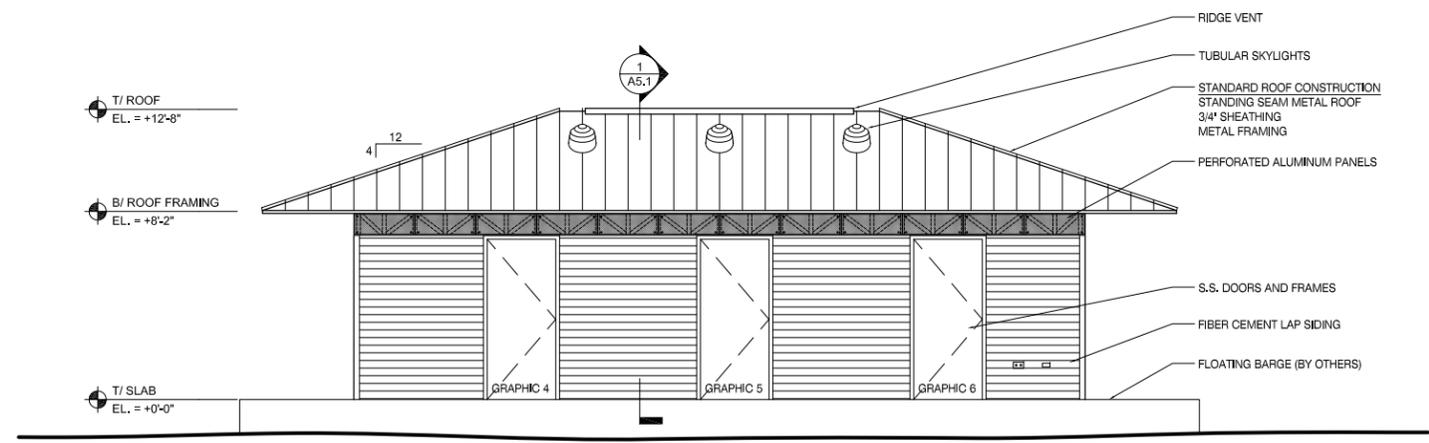
SHEET TITLE
REFLECTED CEILING PLAN (JACKSON)

DRAWN: NAP	SHEET NO.
CHECKED: TS	A2.1 J
APPROVED: TS	
JOB NO. 10.09.10	

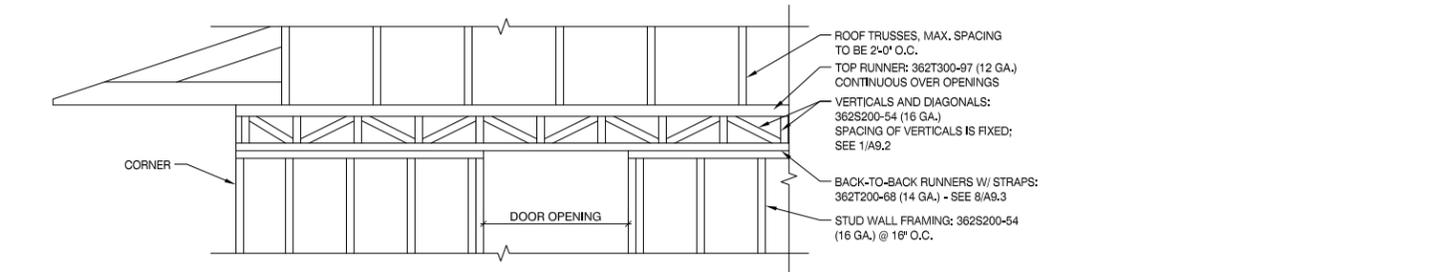
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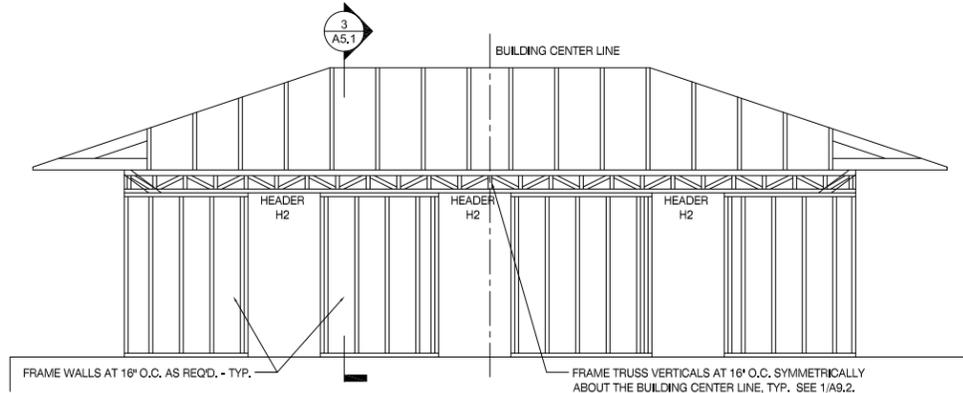
1 SIDE ELEVATION
SCALE: 1/8" = 1'-0"



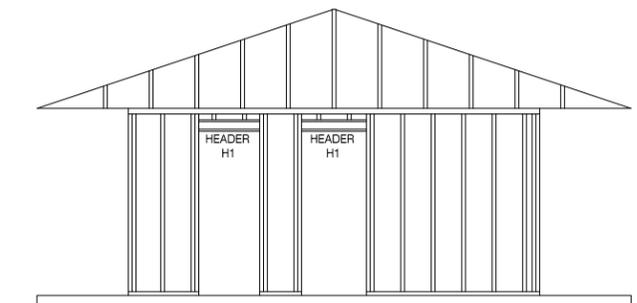
2 SIDE ELEVATION
SCALE: 1/8" = 1'-0"



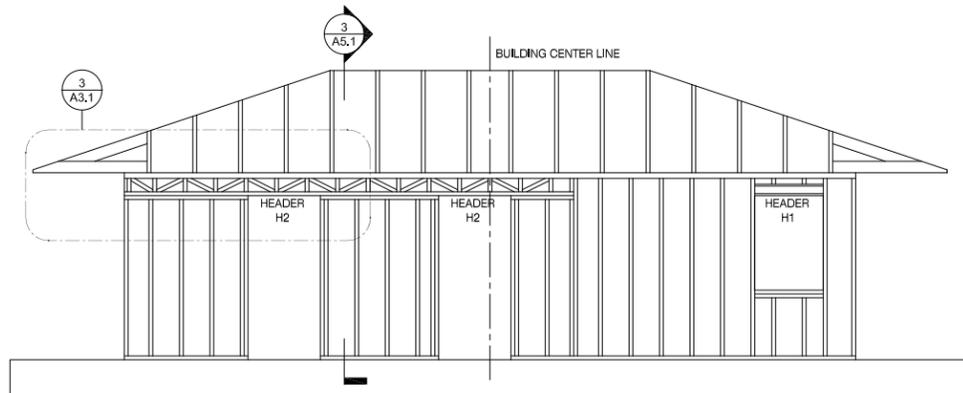
3 PARTIAL FRAMING ELEVATION
SCALE: 1/4" = 1'-0"



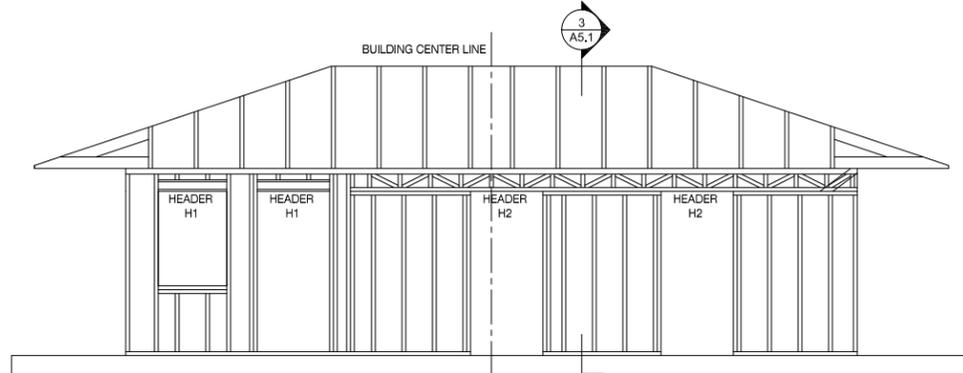
4 FRAMING ELEVATION - TYPICAL LONG WALL
SCALE: 1/8" = 1'-0"



5 FRAMING ELEVATION - TYPICAL SHORT WALL
SCALE: 1/8" = 1'-0"



6 FRAMING ELEVATION - JACKSON
SCALE: 1/8" = 1'-0"



7 FRAMING ELEVATION - JACKSON
SCALE: 1/8" = 1'-0"

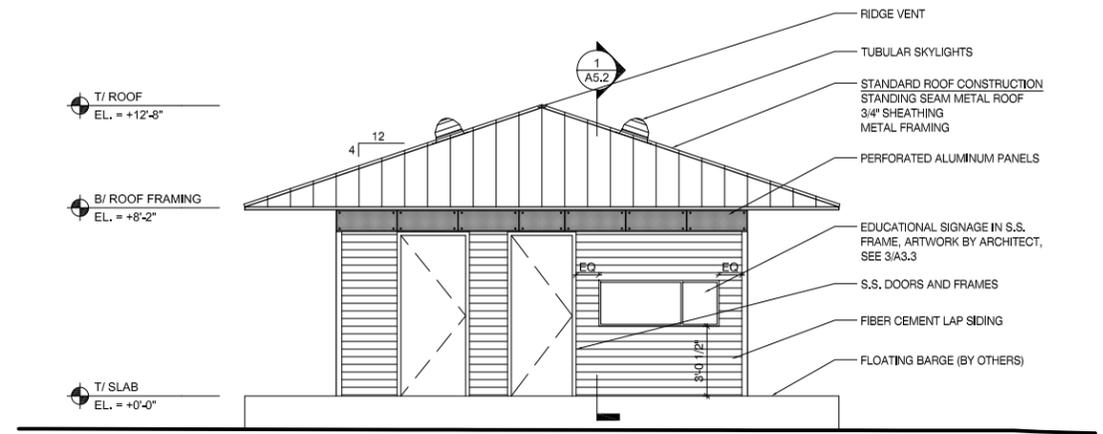
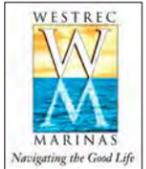
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PROJECT
WESTREC FLOATING WASHROOMS

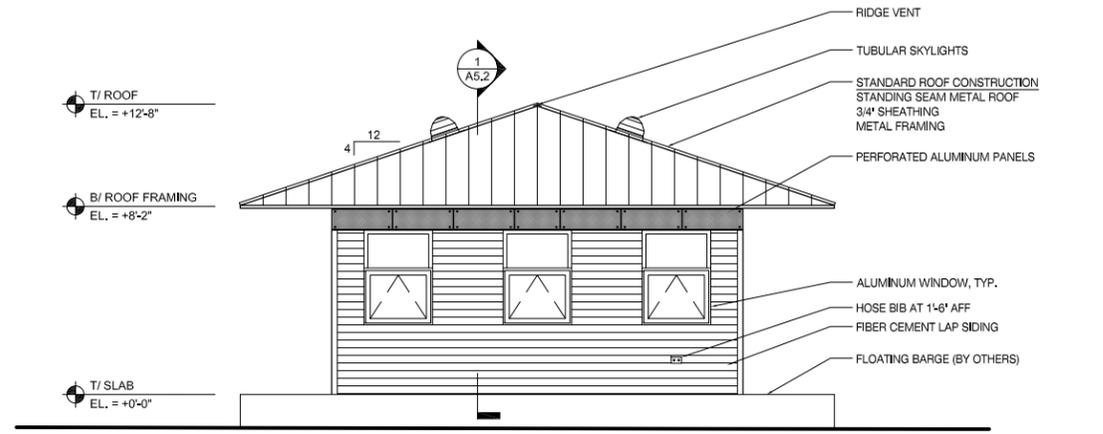
SHEET TITLE
ELEVATIONS

DRAWN: NAP	SHEET NO.
CHECKED: TS	A3.1
APPROVED: TS	
JOB NO. 10.09.10	

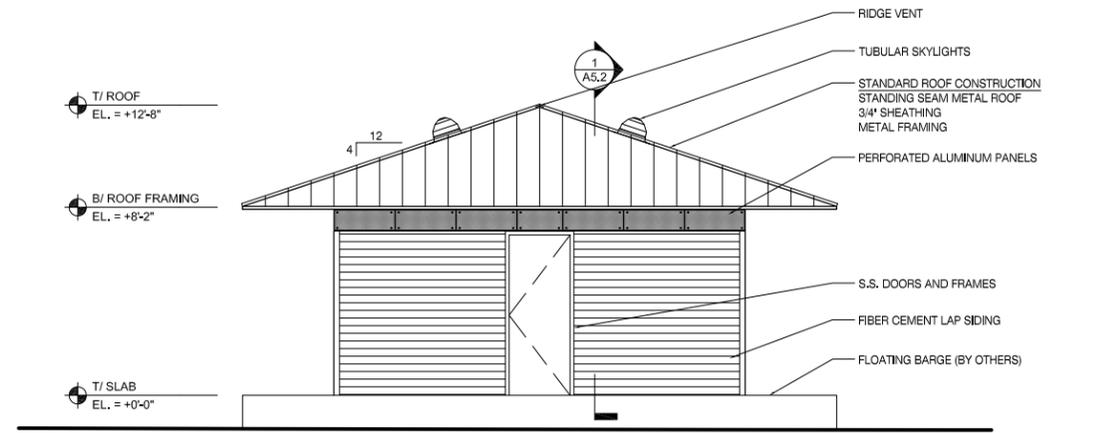
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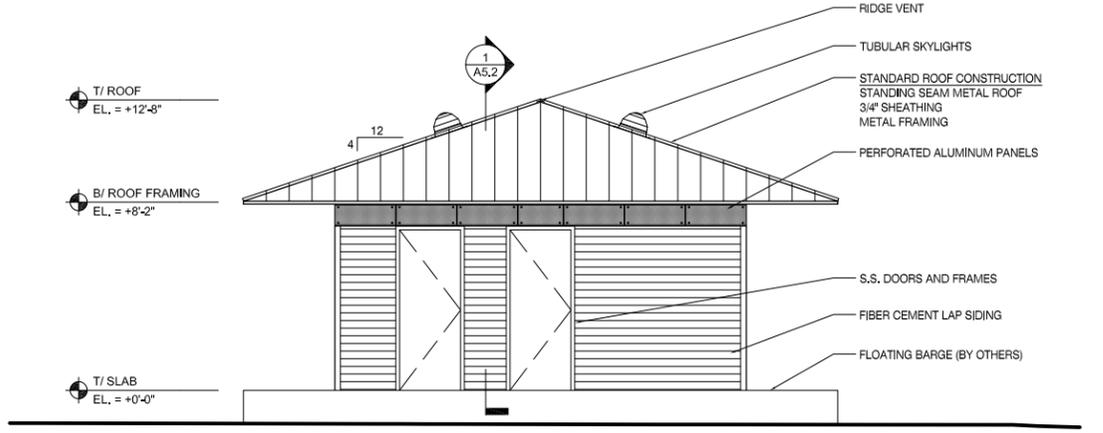
1 FRONT ELEVATION
SCALE: 1/8" = 1'-0"
0 2' 4' 8' 16' 24'



3 FRONT ELEVATION - JACKSON
SCALE: 1/8" = 1'-0"
0 2' 4' 8' 16' 24'



2 REAR ELEVATION
SCALE: 1/8" = 1'-0"
0 2' 4' 8' 16' 24'



4 REAR ELEVATION - JACKSON
SCALE: 1/8" = 1'-0"
0 2' 4' 8' 16' 24'

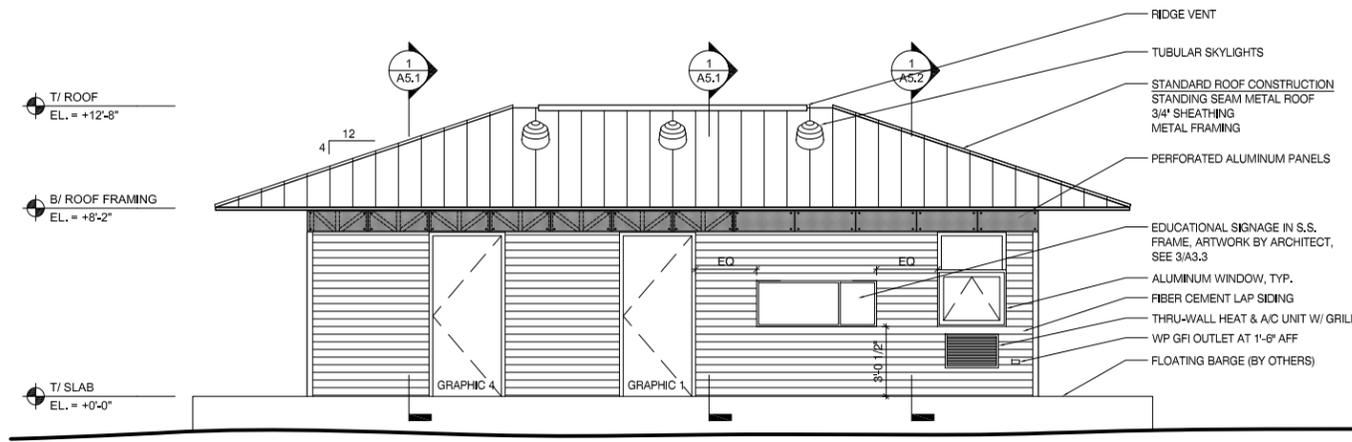
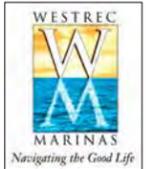
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1	01/20/2011	SCHEMATIC DESIGN

PROJECT
WESTREC FLOATING WASHROOMS

SHEET TITLE
ELEVATIONS

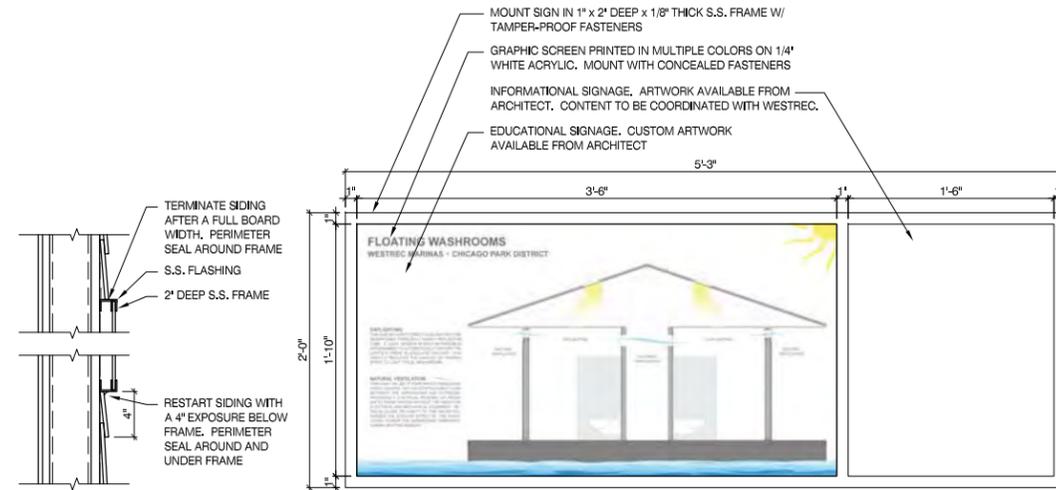
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CHECKED: TS	A3.2
APPROVED: TS	
JOB NO. 10.09.10	

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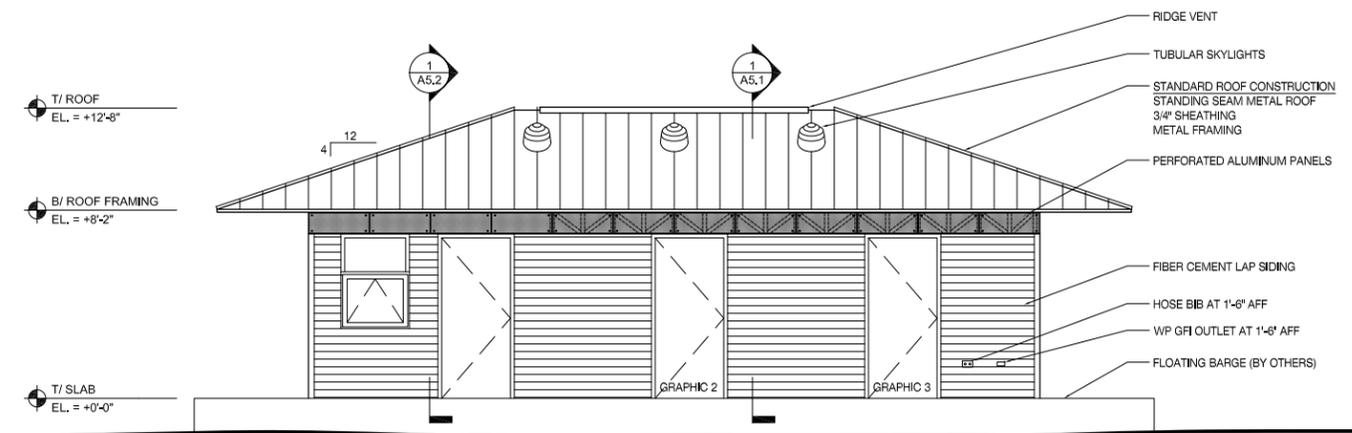
1 SIDE ELEVATION - JACKSON

SCALE: 1/8" = 1'-0"



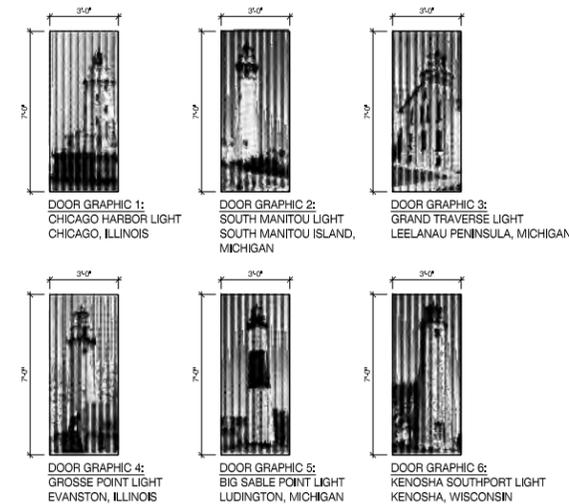
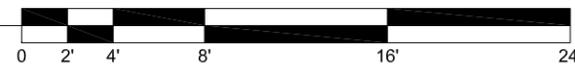
3 SIGN DETAILS

SCALE: 3/4" = 1'-0"



2 SIDE ELEVATION - JACKSON

SCALE: 1/8" = 1'-0"



DOOR GRAPHICS NOTES:
S.S. DOORS TO RECEIVE LITHOGRAPHIC PHYSICAL ETCHING ON EXTERIOR SIDE OF DOOR. SEE ELEVATIONS FOR LOCATIONS. ARTWORK AVAILABLE FROM ARCHITECT IN VECTOR FORMAT DURING CONSTRUCTION. GRAPHIC TO BE POSITIVE ETCH TO MATCH ARCHITECT'S APPROVED SAMPLE FROM FORMS+SURFACES.

MANUFACTURER RECOMMENDED CLEANING INSTRUCTIONS:
FINGERPRINTS AND SMUDGES CAN BE REMOVED USING A NON-CHLORINATED SPRAY CLEANER/DEGREASER SUCH AS SIMPLE GREEN® AND A MICROFIBER CLOTH. DO NOT USE HARSH ABRASIVES, ACIDS OR CHLORINE-BASED CLEANERS OR CLEANING TOOLS CONTAINING CARBON STEEL, SUCH AS STEEL WOOL OR WIRE BRUSHES. HEAVIER SOILING OR SUPERFICIAL DISCOLORATION CAN BE REMOVED USING A PASTE OF BAKING SODA ON A DAMP SPONGE OR SCOTCH-BRITE® LIGHT DUTY CLEANING PAD. RUB THE SURFACE GENTLY AND EVENLY AND THEN RINSE WITH FRESH WATER, DRY WITH A SOFT CLOTH. STAINLESS STEEL'S BRIGHT APPEARANCE CAN BE MAINTAINED BY OCCASIONAL POLISHING WITH A SOFT CLOTH DIPPED IN COMMON HOUSEHOLD WHITE VINEGAR. COMMERCIAL PRODUCTS SPECIFICALLY FORMULATED FOR STAINLESS STEEL SUCH AS 3M™ STAINLESS STEEL CLEANER AND POLISH MAY ALSO BE USED.

FOR MORE INFORMATION CONTACT FORMS+SURFACES OR VISIT WWW.FORMS-SURFACES.COM

4 DOOR GRAPHICS

SCALE: 1/8" = 1'-0"

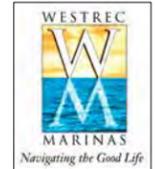
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1	01/20/2011	SCHEMATIC DESIGN

PROJECT
WESTREC FLOATING WASHROOMS

SHEET TITLE
ELEVATIONS

DRAWN: NAP	SHEET NO.
CHECKED: TS	A3.3
APPROVED: TS	
JOB NO. 10.09.10	

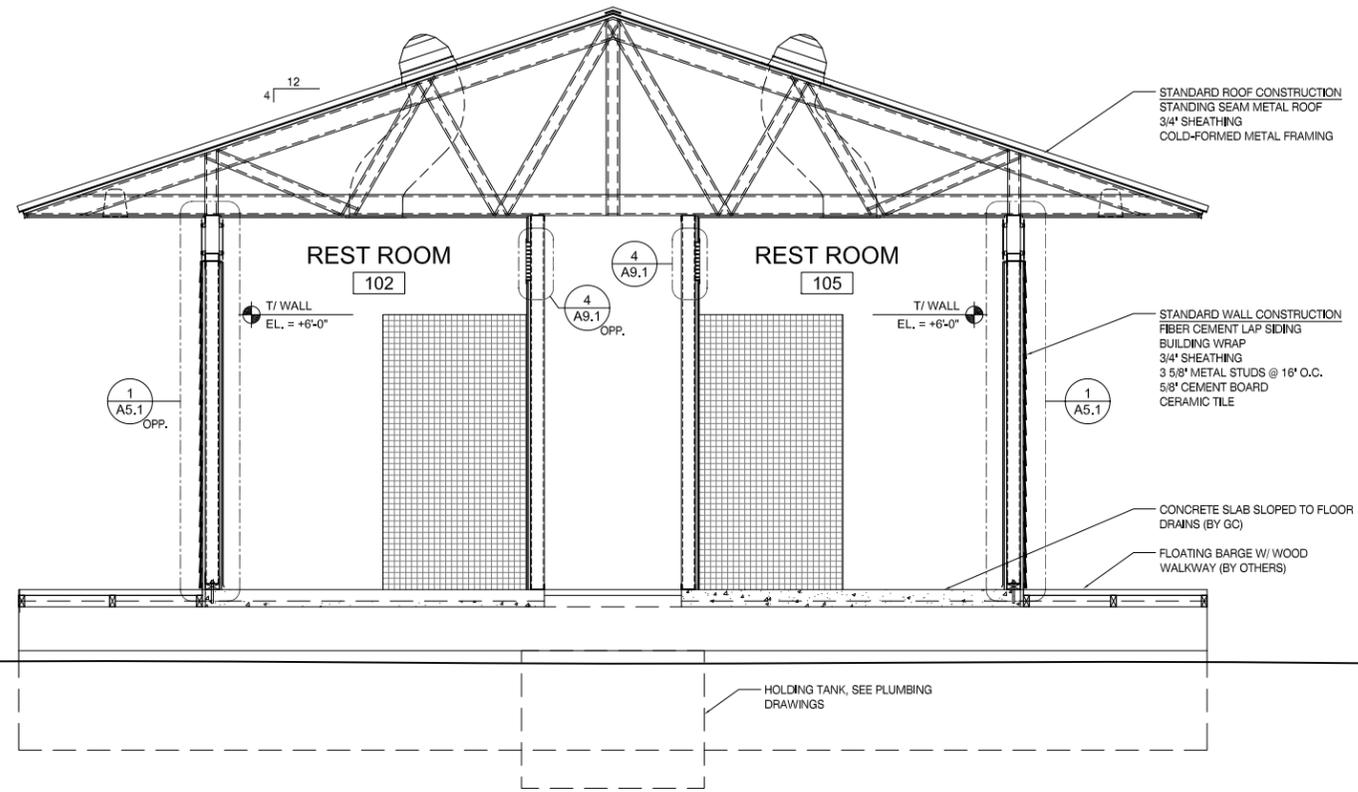
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T/ ROOF
EL. = +12'-8"

B/ ROOF FRAMING
EL. = +8'-2"

T/ SLAB
EL. = +0'-0"



1 BUILDING SECTION
SCALE: 1/4" = 1'-0"



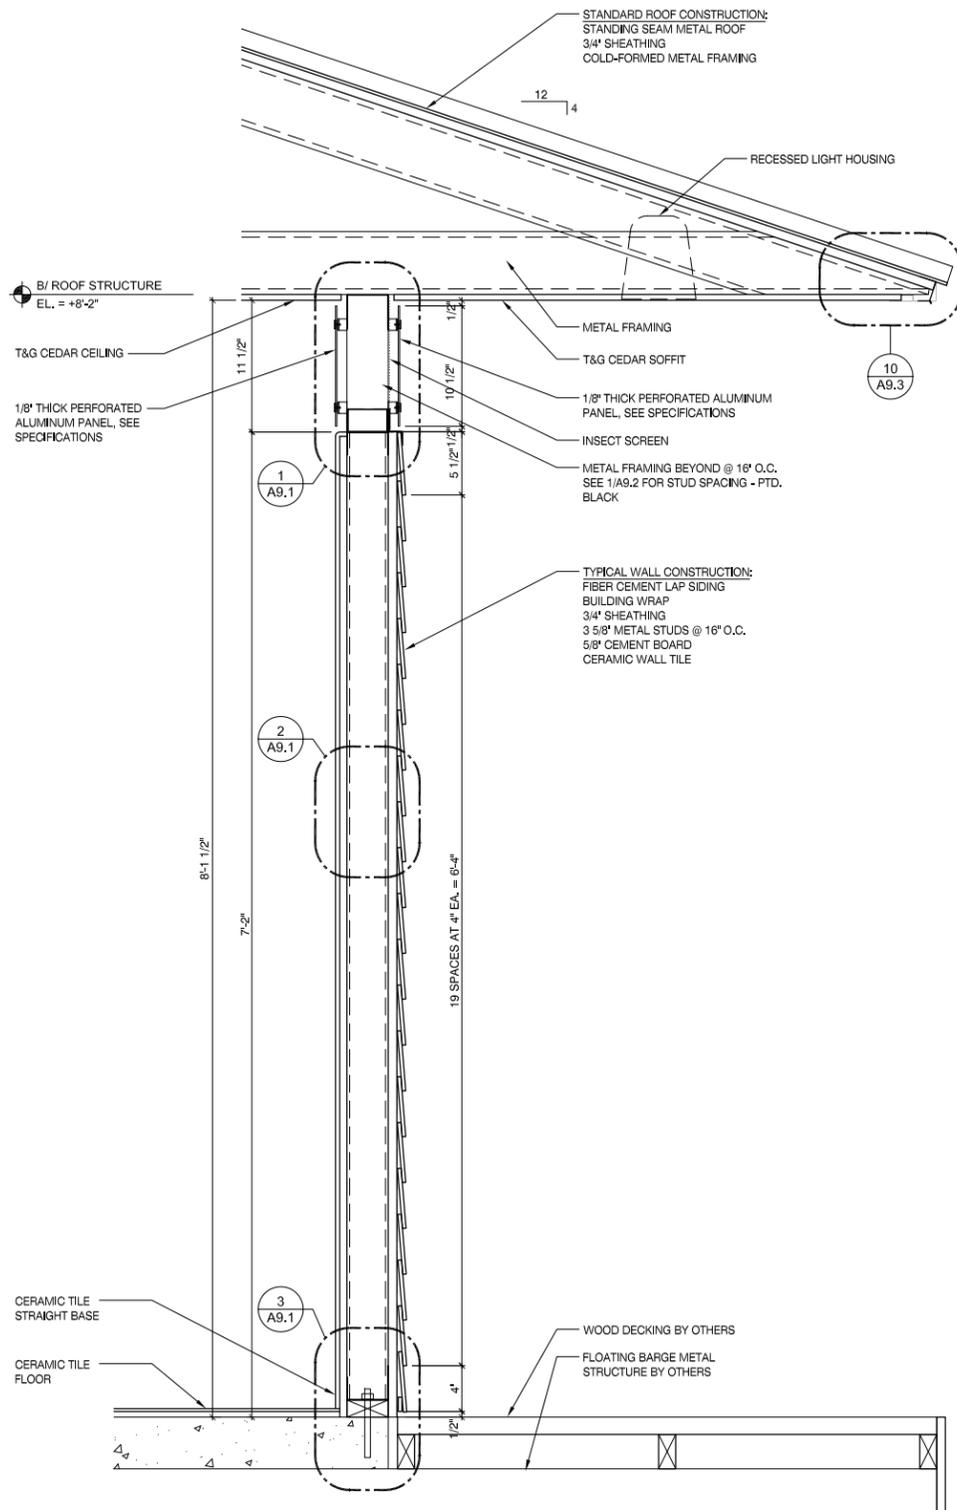
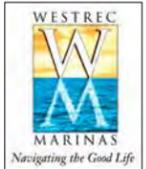
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1	01/20/2011	SCHEMATIC DESIGN
NO	DATE	ISSUED FOR

PROJECT
WESTREC FLOATING WASHROOMS

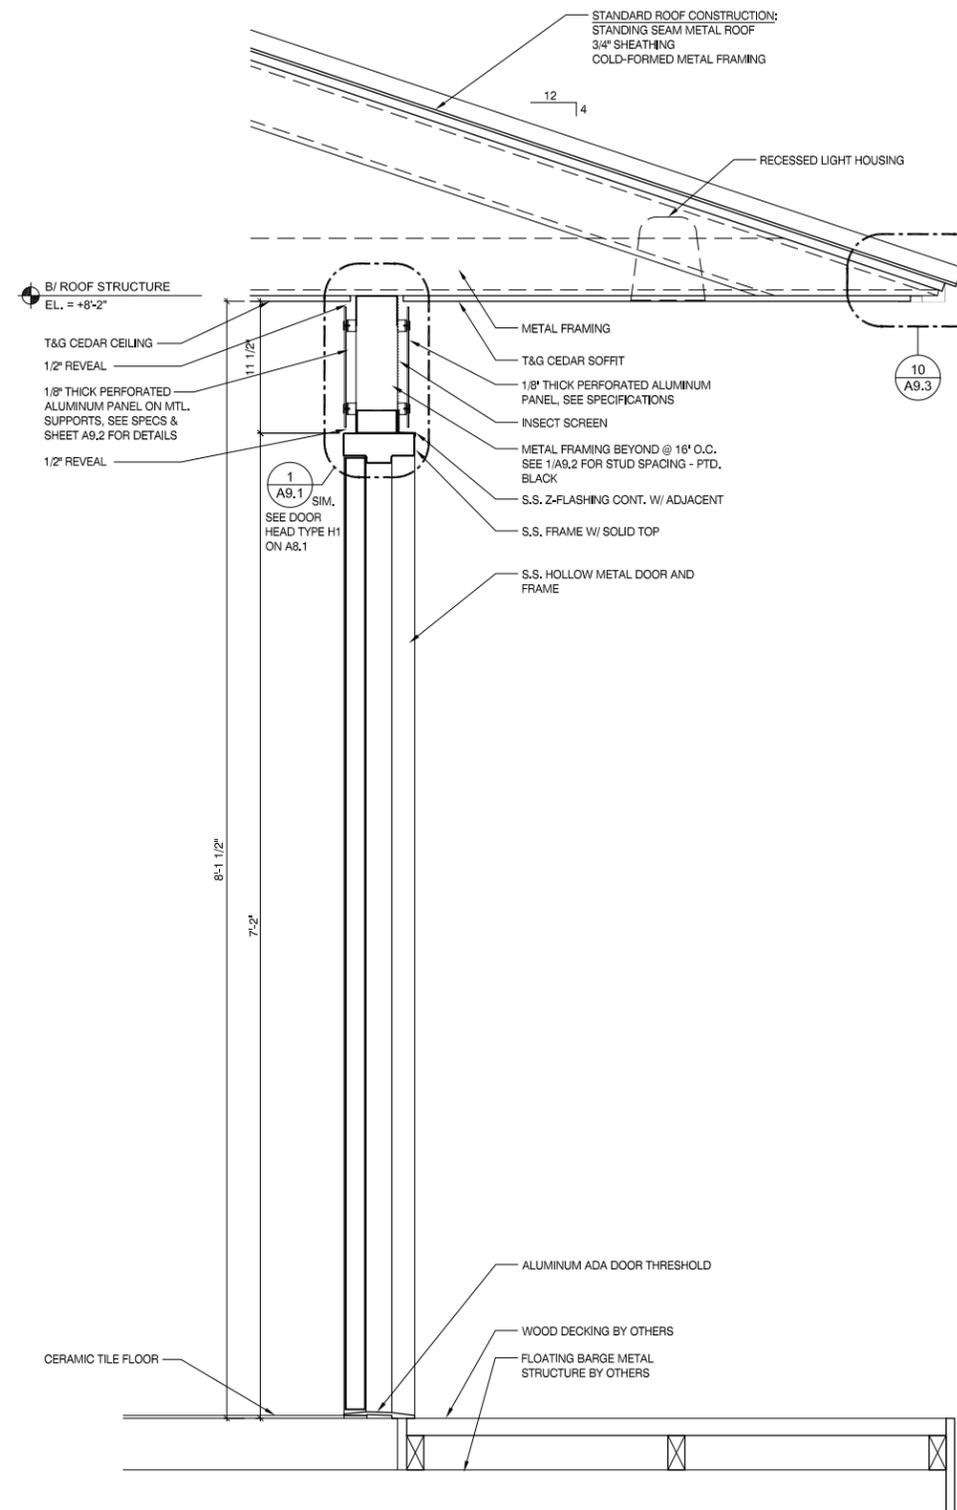
SHEET TITLE
BUILDING SECTION

DRAWN: NAP	SHEET NO. A4.1
CHECKED: TS	
APPROVED: TS	
JOB NO. 10.09.10	

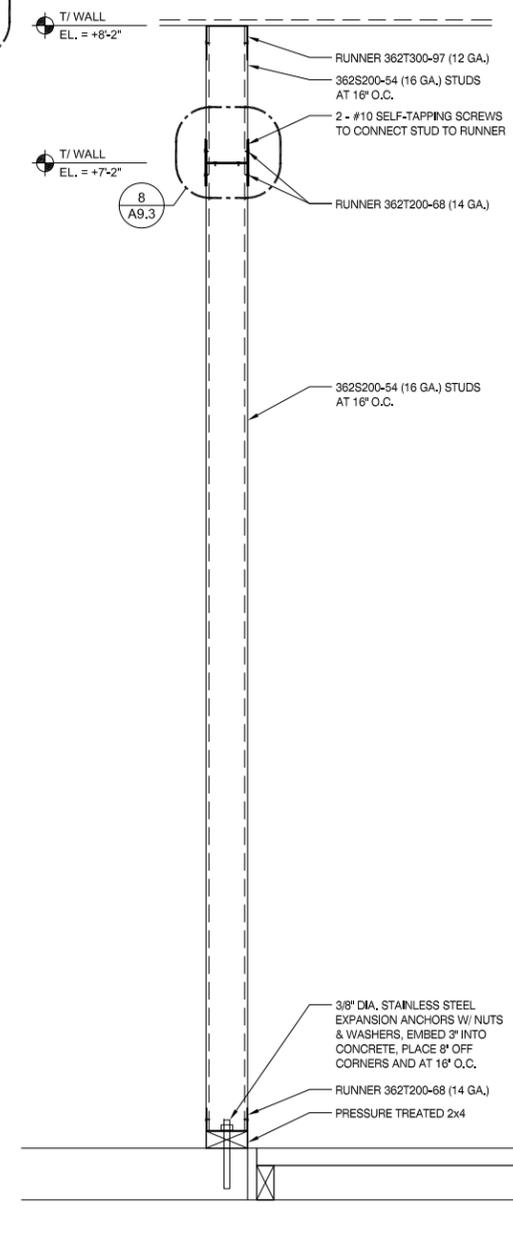
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1 WALL SECTION
SCALE: 3/4" = 1'-0"
0 4" 8" 1' 2' 4'



2 WALL SECTION
SCALE: 3/4" = 1'-0"
0 4" 8" 1' 2' 4'



3 TYPICAL EXT. WALL FRAMING
SCALE: 3/4" = 1'-0"

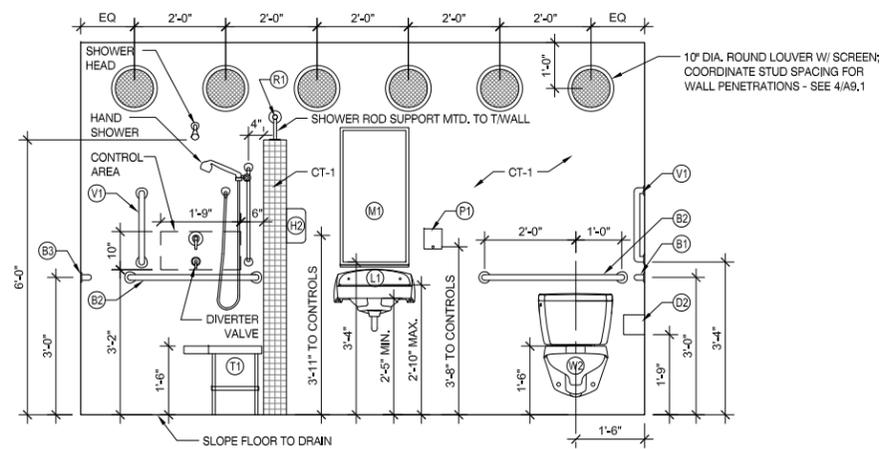
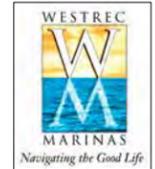
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1	01/20/2011	SCHEMATIC DESIGN

PROJECT
WESTREC FLOATING WASHROOMS

SHEET TITLE
WALL SECTIONS

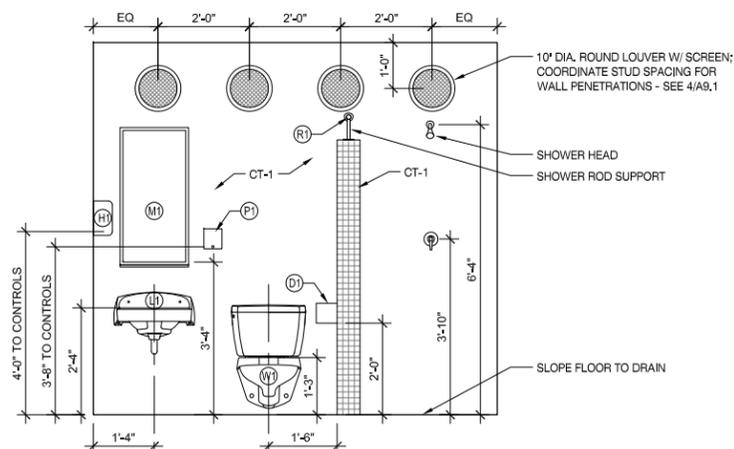
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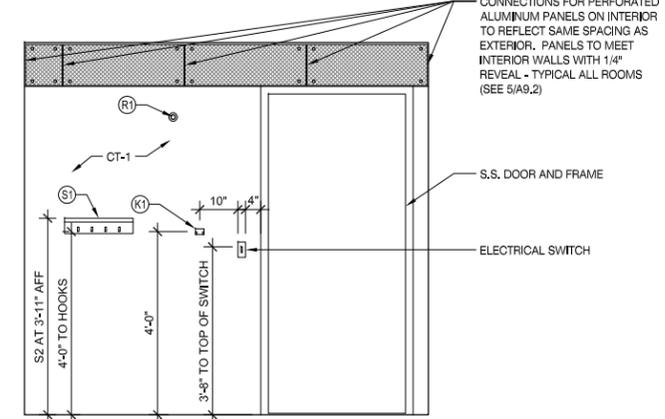
1 ADA RESTROOM ELEVATION

SCALE: 1/4" = 1'-0"



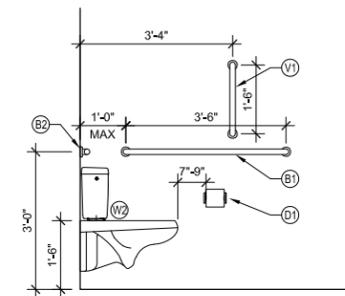
2 TYPICAL RESTROOM ELEVATION

SCALE: 1/4" = 1'-0"



3 TYPICAL RESTROOM ELEVATION

SCALE: 1/4" = 1'-0"



4 ADA TOILET

SCALE: 1/4" = 1'-0"

ACCESSORY	MOUNTING	ACCESSORY	MOUNTING
(B1) 42" HORIZONTAL GRAB BAR	MOUNT AT 3'-0" AFF TO CL OF BAR	(V1) 18" VERTICAL GRAB BAR	MOUNT 4" ABOVE HORIZ. BAR
(B2) 36" HORIZONTAL GRAB BAR	MOUNT AT 3'-0" AFF TO CL OF BAR	(P1) SOAP DISPENSOR	MOUNT AT 3'-8" AFF TO CONTROLS
(B3) 42" OR 48" HORIZ. GRAB BAR	MOUNT AT 3'-0" AFF TO CL OF BAR	(S1) 18" SHELF WITH HOOKS	MOUNT AT 4'-0" AFF TO HOOKS
(C1) BABY CHANGING STATION	MOUNT AT 4'-0" AFF TO HANDLE	(S2) 18" SHELF WITH HOOKS	MOUNT AT 3'-11" AFF TO SHELF
(D1) TOILET PAPER DISPENSOR	MOUNT AT 2'-0" AFF TO PAPER OUTLET	(W1) TYPICAL WATER CLOSET	MOUNT SEAT HEIGHT AT 1'-3" AFF CENTERLINE OF TOILET 1'-6"
(D2) TOILET PAPER DISPENSOR	MOUNT AT 1'-9" AFF TO PAPER OUTLET MIN. 1 1/2" CLEAR OF GRAB BAR	(W2) ADULT ADA WATER CLOSET	MOUNT SEAT HEIGHT AT 1'-6" AFF CENTERLINE OF TOILET 1'-6"
(H1) ELECTRIC HAND DRYER	MOUNT AT 4'-0" AFF TO CONTROLS	(L1) TYPICAL LAVATORY	MOUNT AT 2'-7" AFF RIM HEIGHT
(H2) ELECTRIC HAND DRYER	MOUNT AT 3'-4" AFF TO CONTROLS	(L2) ADULT ADA LAVATORY	MOUNT AT 2'-10" AFF MAX. RIM HEIGHT, 2'-5" MIN. KNEE SPACE.
(K1) DOUBLE TOWEL HOOK	MOUNT AT 4'-0" AFF	(R1) CURTAIN ROD OR 1 1/4" O.D. CHROME-PLATED PIPE W/ WALL MOUNTS	MOUNT AT 6'-8" AFF TO CENTERLINE OF ROD
(M1) MIRROR W/ SHELF	MOUNT AT 3'-4" AFF TO BOTTOM OF REFLECTIVE SURFACE		
(T1) ADA SHOWER SEAT	MOUNT AT 1'-6" AFF TO TOP OF SEAT		

Finish Legend		
Symbol	Material	Description
Floor		
CT-2	Ceramic Tile	2"x2" tile; Basis of Design: Daltile #D202 "Uptown Taupe Speckle"
CT-3	Ceramic Tile	6.5"x20" tile; Basis of Design: Daltile #CN94 "Eastside Brown"
CONC	Concrete	Smooth finish
Wall		
CT-1	Ceramic Tile	2"x2" tile; Basis of Design: Daltile #D161 "Urban Putty"
PT-1	Paint	Basis of Design: Benjamin Moore "White Dove"
PT-2	Paint	Basis of Design: Benjamin Moore #2125-10 "Black Panther"
Base		
WOOD	Wood	4" Cedar
VINYL	Vinyl Base	4" base; Basis of Design: Armstrong #15 "Zinc"
Exterior		
SIDING	Fiber Cement Bd	4" exposure; Basis of Design: HardiePlank "Cobble Stone"
ROOF	Metal	Basis of Design: Peterson Aluminum color "Silver"

Room Finish Schedule					
Room No.	Room Name	Floor Finish	Base	Wall Finish	Ceiling Finish
101	Rest Room	CT-2	CT-1	CT-1	WOOD
102	Rest Room	CT-2	CT-1	CT-1	WOOD
103	Rest Room	CT-2	CT-1	CT-1	WOOD
104	Electrical	CONC	VINYL	GYP BD PT-1	GYP BD PT-1
105	Rest Room	CT-2	CT-1	CT-1	WOOD
106	Rest Room	CT-2	CT-1	CT-1	WOOD
107	ADA Rest Room	CT-2	CT-1	CT-1	WOOD
108	Plumbing Chase	N/A	N/A	N/A	N/A
109	Utility	CONC	VINYL	GYP BD PT-1	GYP BD PT-1
110	Office	CT-3	WOOD	GYP BD PT-1	WOOD
111	Closest	CT-3	WOOD	GYP BD PT-1	GYP BD PT-1

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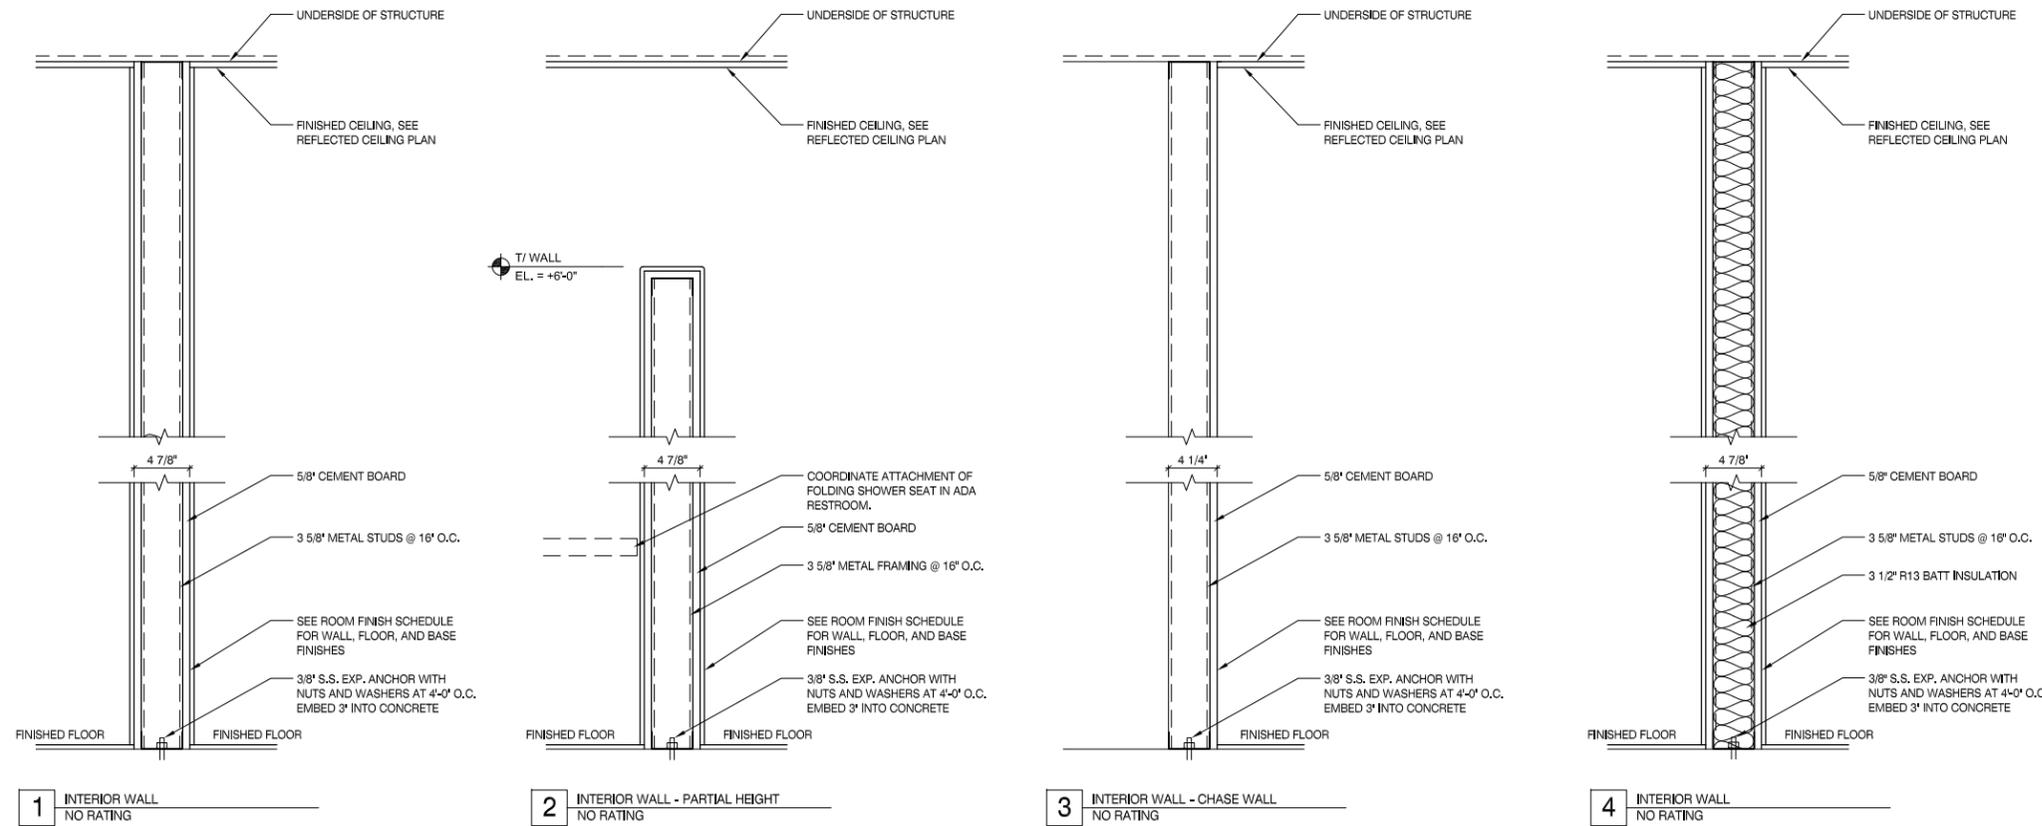
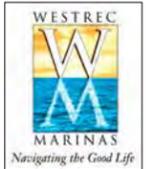
PROJECT
WESTREC FLOATING WASHROOMS

SHEET TITLE
INTERIOR ELEVATIONS

DRAWN: NAP
CHECKED: TS
APPROVED: TS
JOB NO. 10.09.10

SHEET NO.
A6.1

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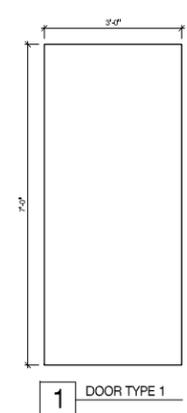


WALL PARTITION TYPES

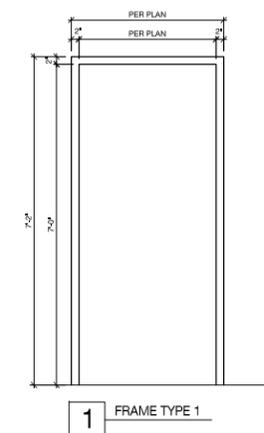
SCALE: 3/4" = 1'-0"



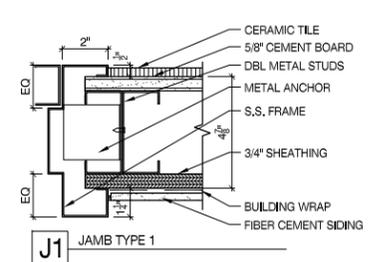
FLOOR	OPNG NO.	ROOM	TYPE	DOOR						OPENING FRAME						GLAZING	REMARKS		
				DOOR SIZE			DOOR DETAILS			MATL	FIN	HWDR SET	TYPE	MAT	FRAME SIZE				
				WIDTH	HGT	THK	HEAD	JAMB	SILL						WIDTH			HGT	
FIRST FLOOR	1	REST ROOM 101	1	3'-0"	7'-0"	1 3/4"	H1	J1	S1	SS	#4	1	1	SS	#4	3'-4"	7'-2"	-	GRAPHIC ETCHING
	2	REST ROOM 102	1	3'-0"	7'-0"	1 3/4"	H1	J1	S1	SS	#4	1	1	SS	#4	3'-4"	7'-2"	-	GRAPHIC ETCHING
	3	REST ROOM 103	1	3'-0"	7'-0"	1 3/4"	H1	J1	S1	SS	#4	1	1	SS	#4	3'-4"	7'-2"	-	GRAPHIC ETCHING
	4	ELECTRICAL 104	1	3'-0"	7'-0"	1 3/4"	H1	J1	S1	SS	#4	3	1	SS	#4	3'-0"	7'-2"	-	
	5	REST ROOM 105	1	3'-0"	7'-0"	1 3/4"	H1	J1	S1	SS	#4	1	1	SS	#4	3'-4"	7'-2"	-	GRAPHIC ETCHING
	6	REST ROOM 106	1	3'-0"	7'-0"	1 3/4"	H1	J1	S1	SS	#4	1	1	SS	#4	3'-4"	7'-2"	-	GRAPHIC ETCHING
	7	ADA REST ROOM 107	1	3'-0"	7'-0"	1 3/4"	H1	J1	S1	SS	#4	1	1	SS	#4	3'-4"	7'-2"	-	GRAPHIC ETCHING
	8	PLUMBING CHASE 108	1	2'-8"	7'-0"	1 3/4"	H1	J1	S2	SS	#4	3	1	SS	#4	3'-0"	7'-2"	-	
	9	UTILITY 109	1	2'-6"	7'-0"	1 3/4"	H1	J1	S1	SS	#4	2	1	SS	#4	2'-10"	7'-2"	-	
	10	OFFICE 110	1	3'-0"	7'-0"	1 3/4"	H1	J1	S1	SS	#4	4	1	SS	#4	3'-4"	7'-2"	-	
	11	CLOSET 111	1	2 @ 2'-6"	7'-0"	1 3/4"	H2	J2	N/A	HM	PT-1	5	1	HM	PT-1	5'-4"	7'-2"	-	
	12	PLUMBING CHASE 108	1	3'-0"	7'-0"	1 3/4"	H2	J2	S1	HM	PT-1	3	1	HM	PT-1	3'-0"	7'-2"	-	



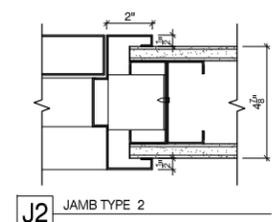
1 DOOR TYPE 1



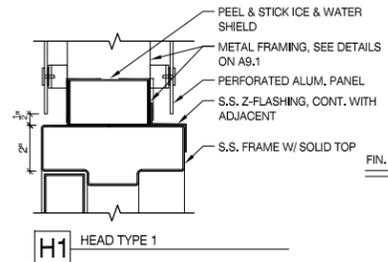
1 FRAME TYPE 1



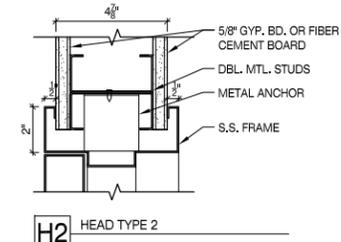
J1 JAMB TYPE 1



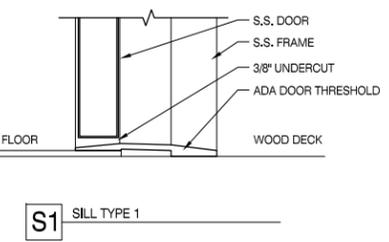
J2 JAMB TYPE 2



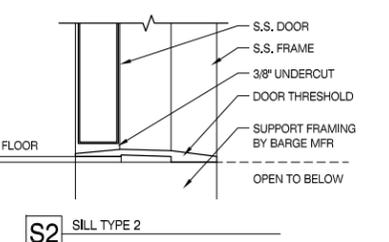
H1 HEAD TYPE 1



H2 HEAD TYPE 2



S1 SILL TYPE 1



S2 SILL TYPE 2

DOOR AND FRAME TYPES

SCALE: 1/4" = 1'-0"



DOOR DETAILS

SCALE: 1/4" = 1'-0"



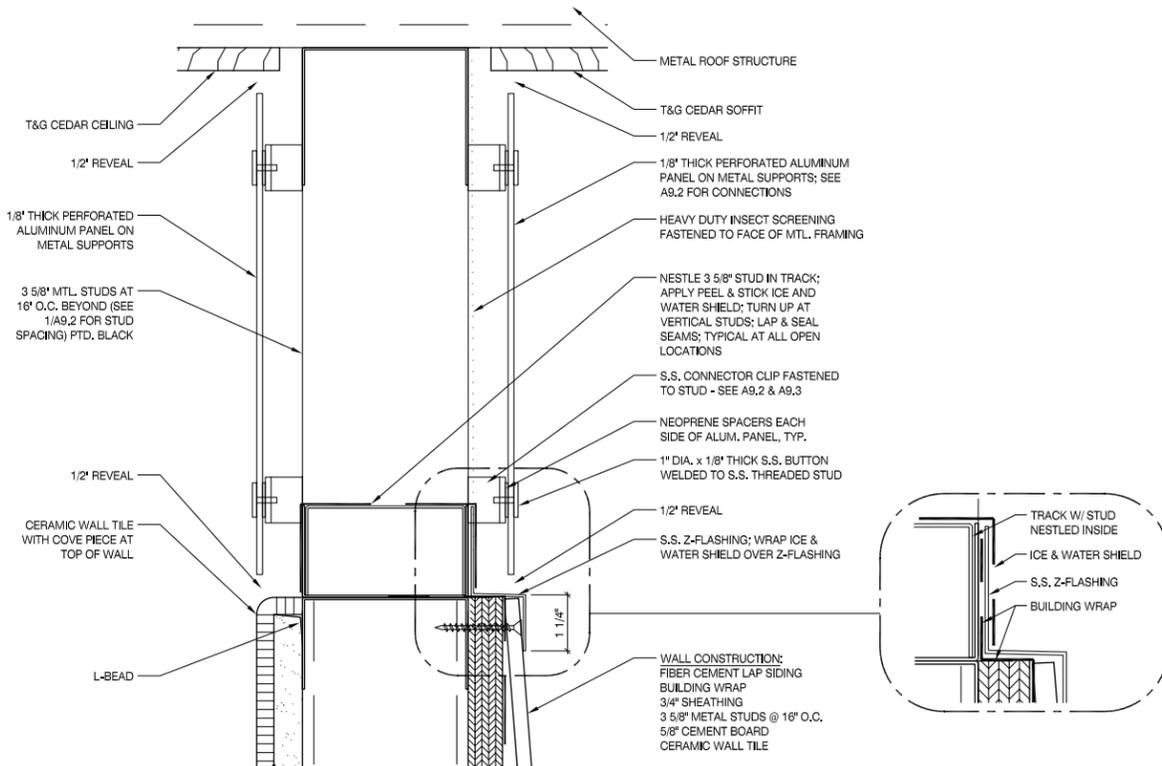
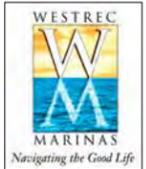
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5	07/18/2011	ISSUE FOR BID
4	07/01/2011	100% DESIGN SUBMITTAL
3	06/06/2011	90% DESIGN / ISSUE FOR PERMIT
2	02/04/2011	30% DESIGN SUBMITTAL
1	01/20/2011	SCHEMATIC DESIGN

PROJECT
WESTREC FLOATING WASHROOMS

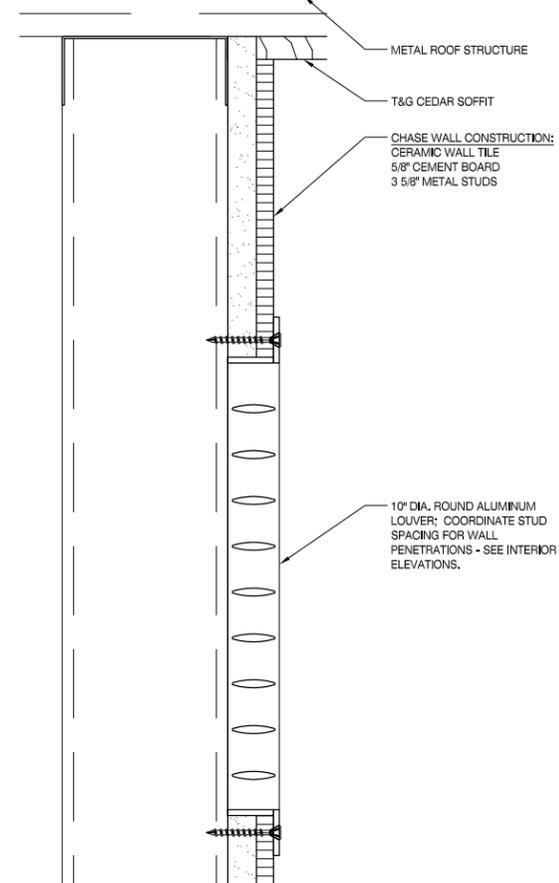
SHEET TITLE
SCHEDULES & DETAILS

DRAWN: NAP	SHEET NO.
CHECKED: TS	A8.1
APPROVED: TS	
JOB NO. 10.09.10	

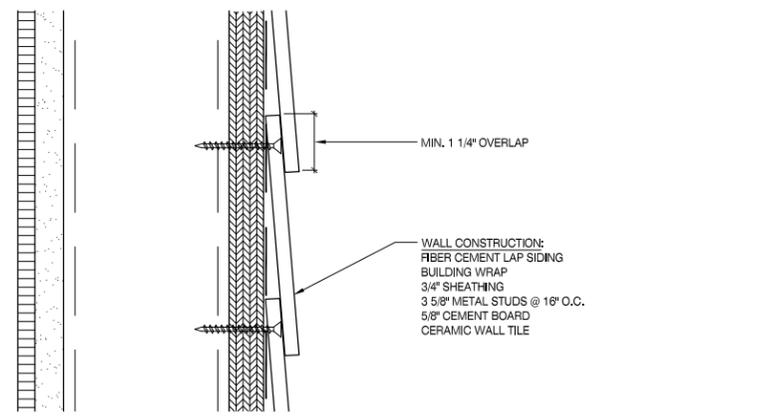
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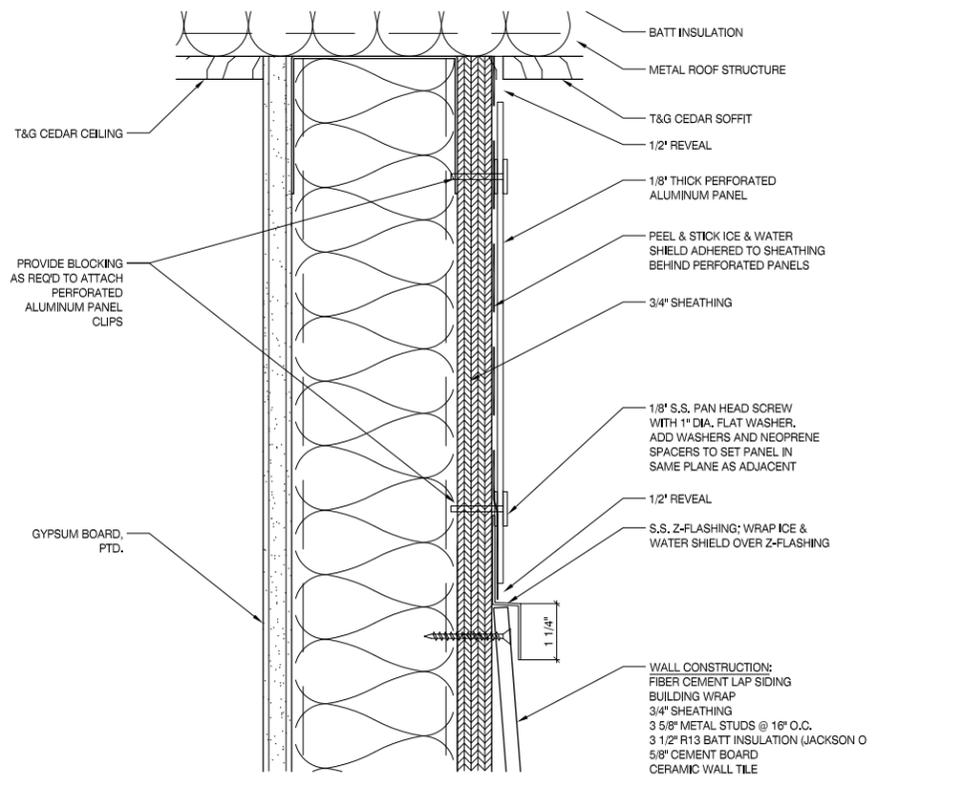
1 ENLARGED DETAIL
SCALE: 3" = 1'-0"
0 4" 8" 1' 2' 4'



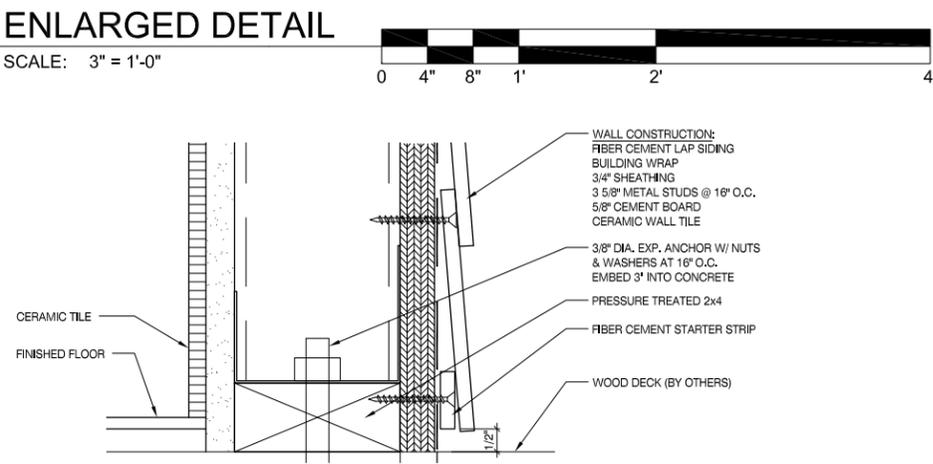
4 ENLARGED DETAIL
SCALE: 3" = 1'-0"
0 4" 8" 1' 2' 4'



2 ENLARGED DETAIL
SCALE: 3" = 1'-0"
0 4" 8" 1' 2' 4'



5 ENLARGED DETAIL
SCALE: 3" = 1'-0"
0 4" 8" 1' 2' 4'



3 ENLARGED DETAIL
SCALE: 3" = 1'-0"
0 4" 8" 1' 2' 4'

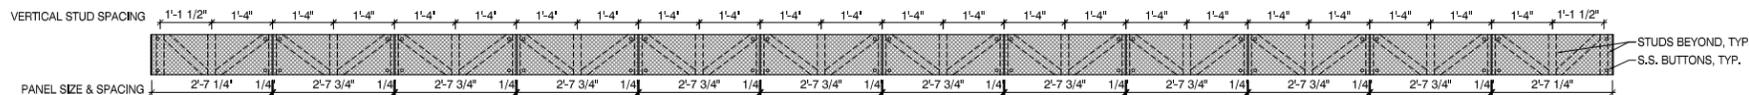
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PROJECT
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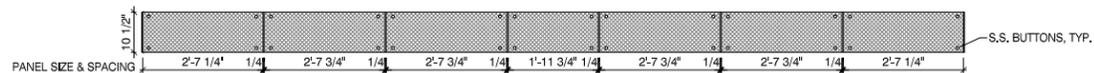
SHEET TITLE
ENLARGED DETAILS

DRAWN: NAP	SHEET NO.
CHECKED: TS	A9.1
APPROVED: TS	
JOB NO. 10.09.10	

BLDG. SIDE ELEVATION:

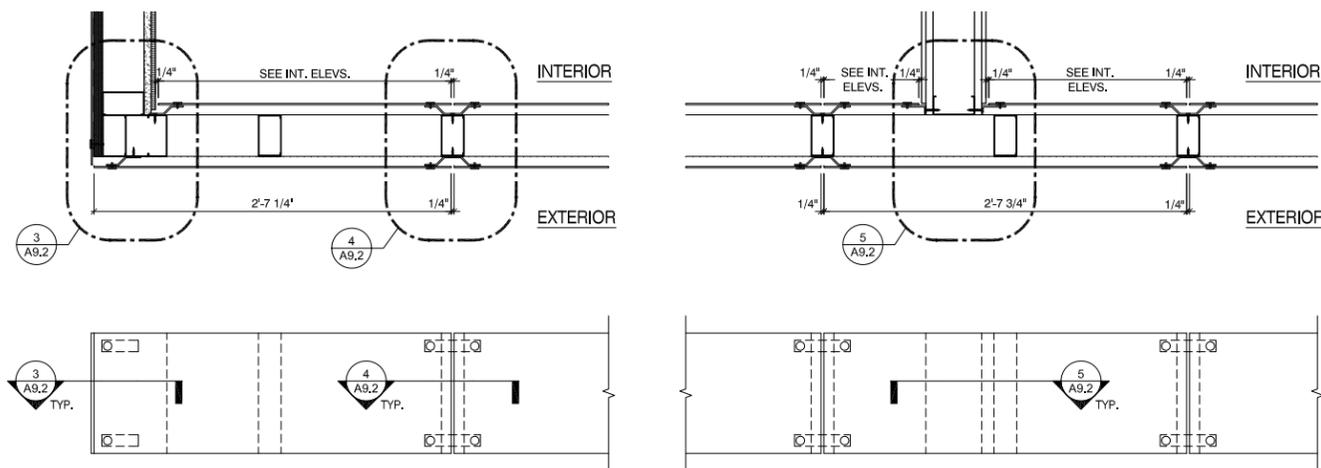


BLDG. FRONT & REAR ELEVATION:



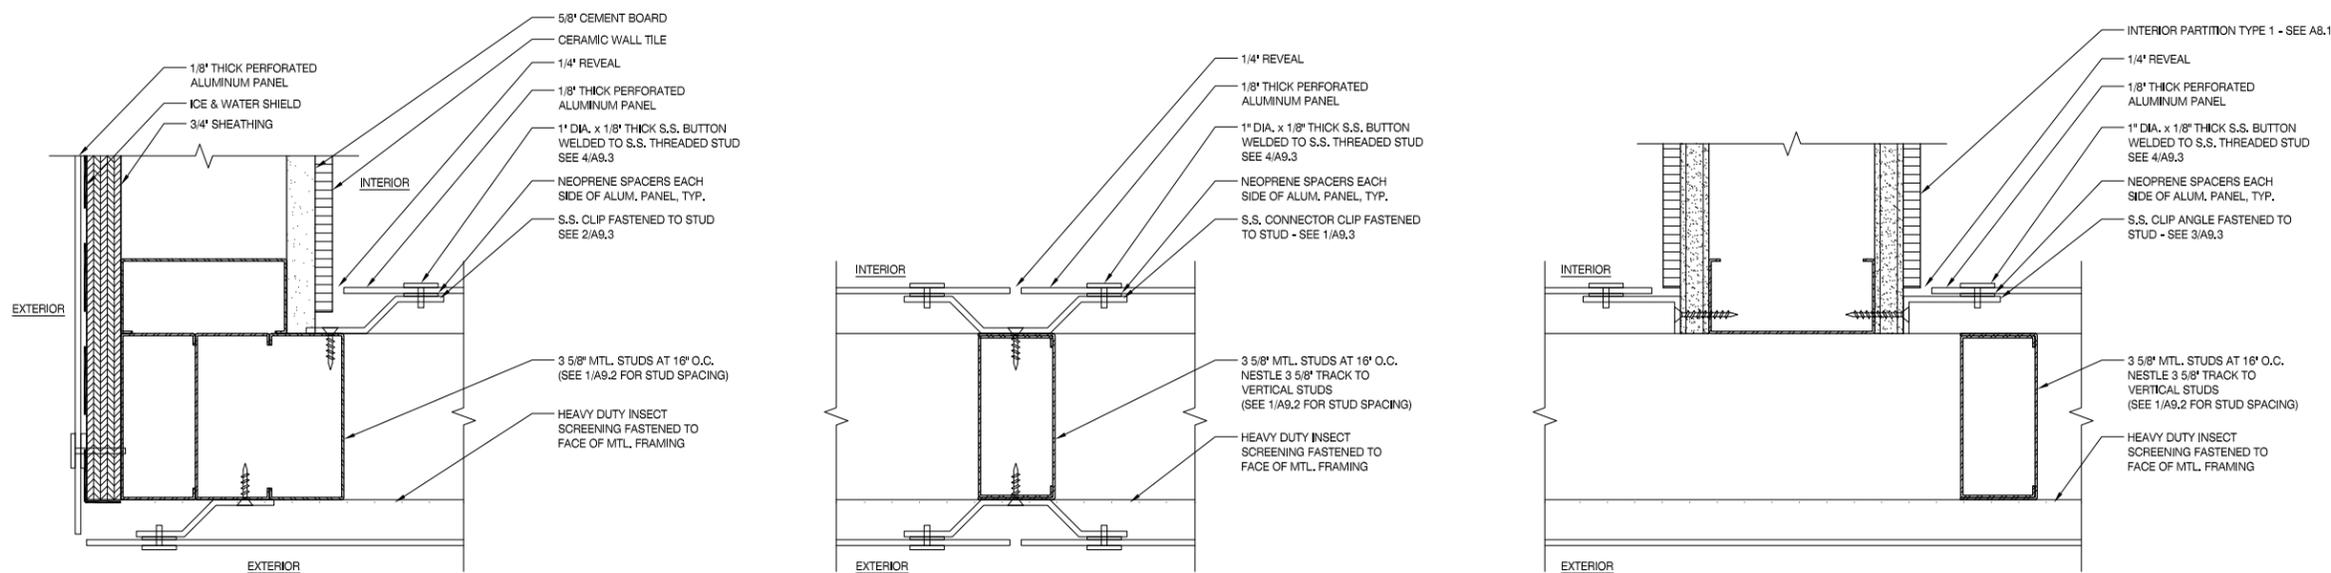
1 ELEVATION DETAILS - PERFORATED PANELS

SCALE: 1/4" = 1'-0"



2 PLAN DETAILS - PERFORATED PANELS

SCALE: 3/4" = 1'-0"



3 PLAN DETAIL

SCALE: 3" = 1'-0"

4 PLAN DETAIL

SCALE: 3" = 1'-0"

5 PLAN DETAIL

SCALE: 3" = 1'-0"

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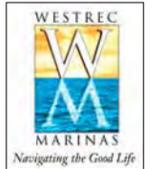
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PROJECT
WESTREC FLOATING WASHROOMS

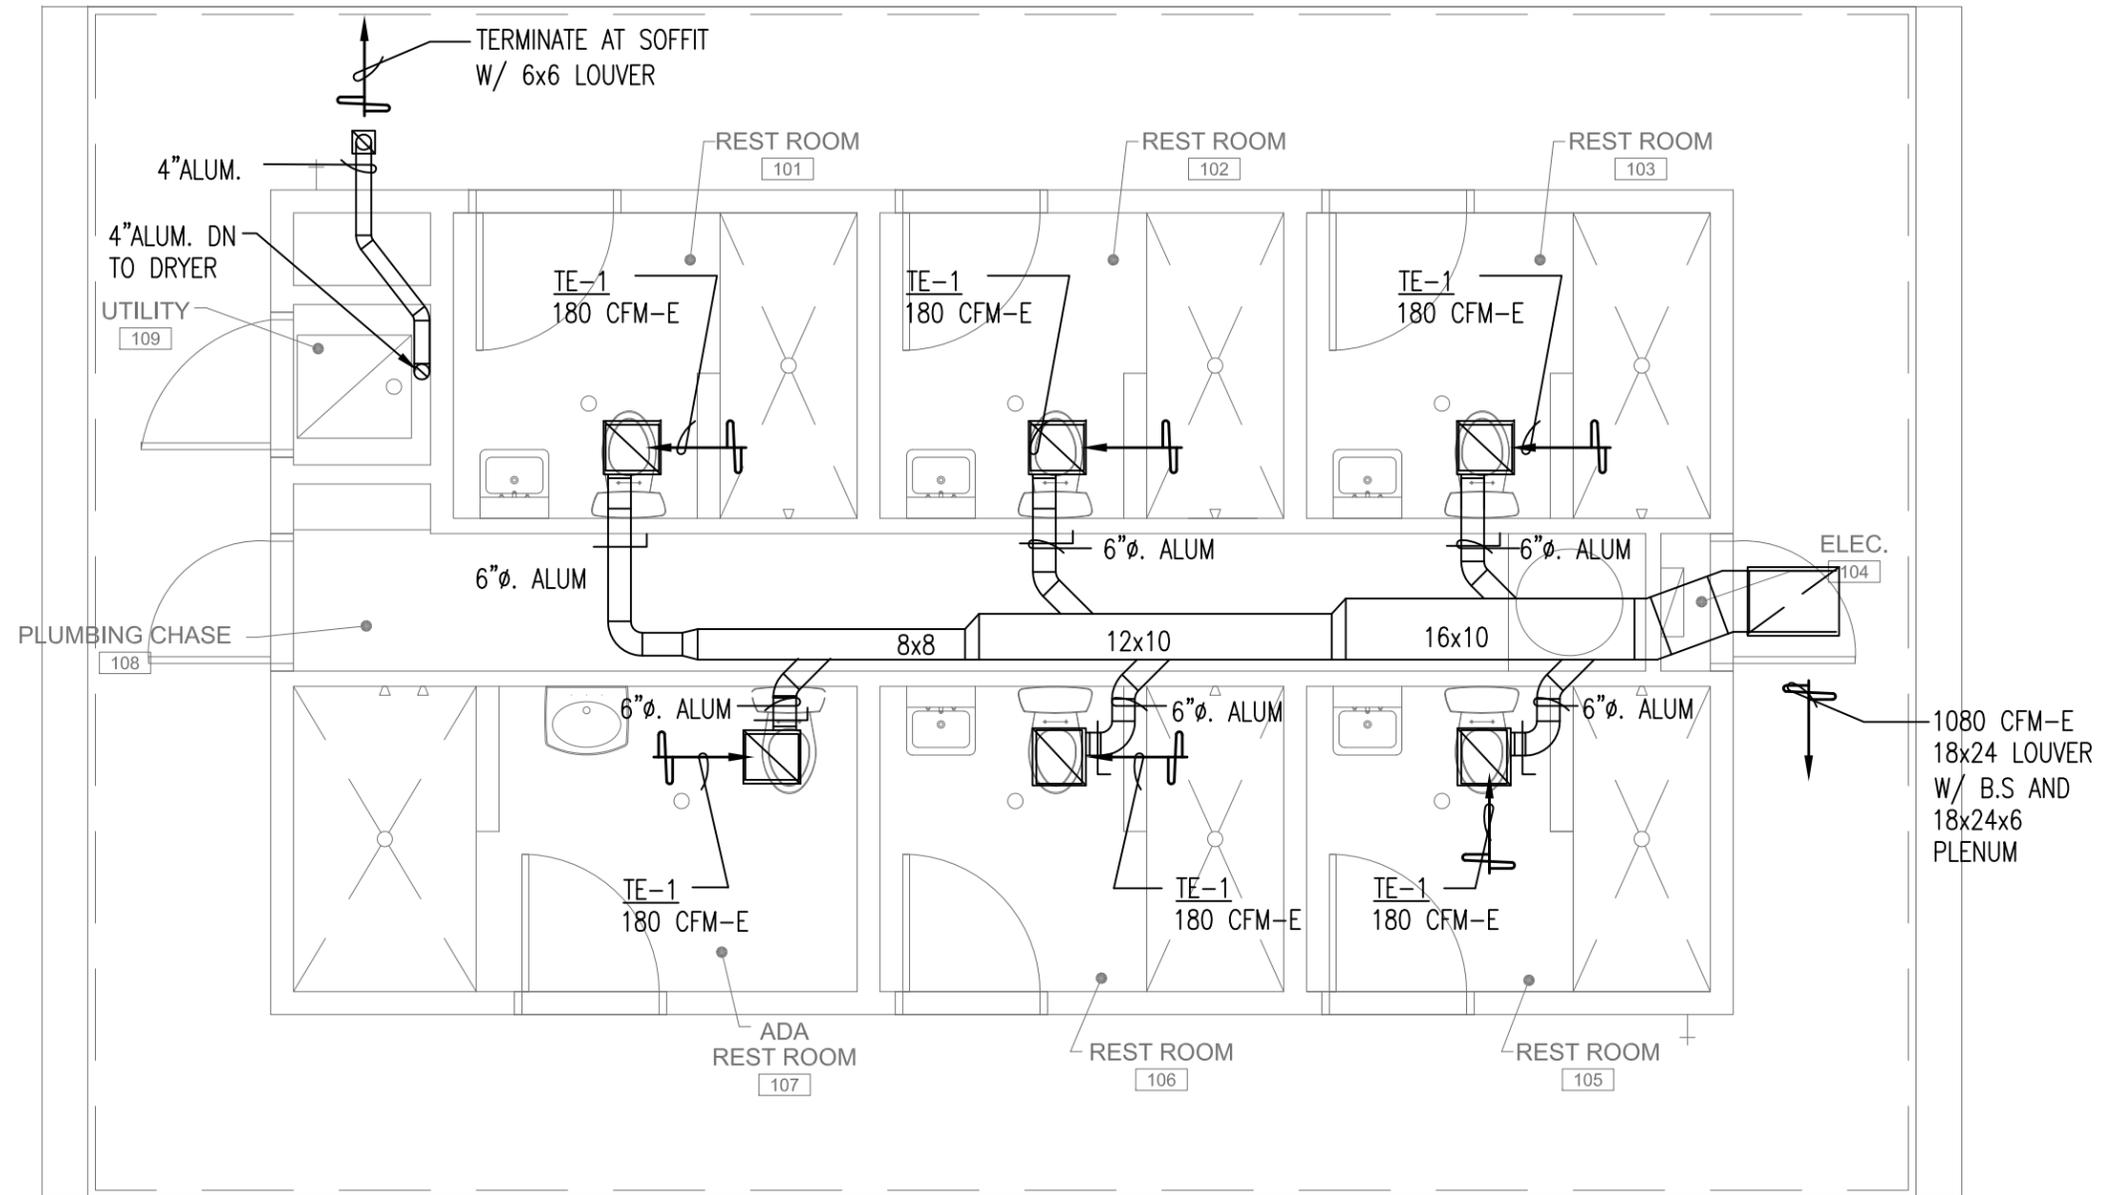
SHEET TITLE
ENLARGED DETAILS

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1 MECHANICAL PLAN
SCALE: 1/4" = 1'-0"

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NO	DATE	ISSUED FOR

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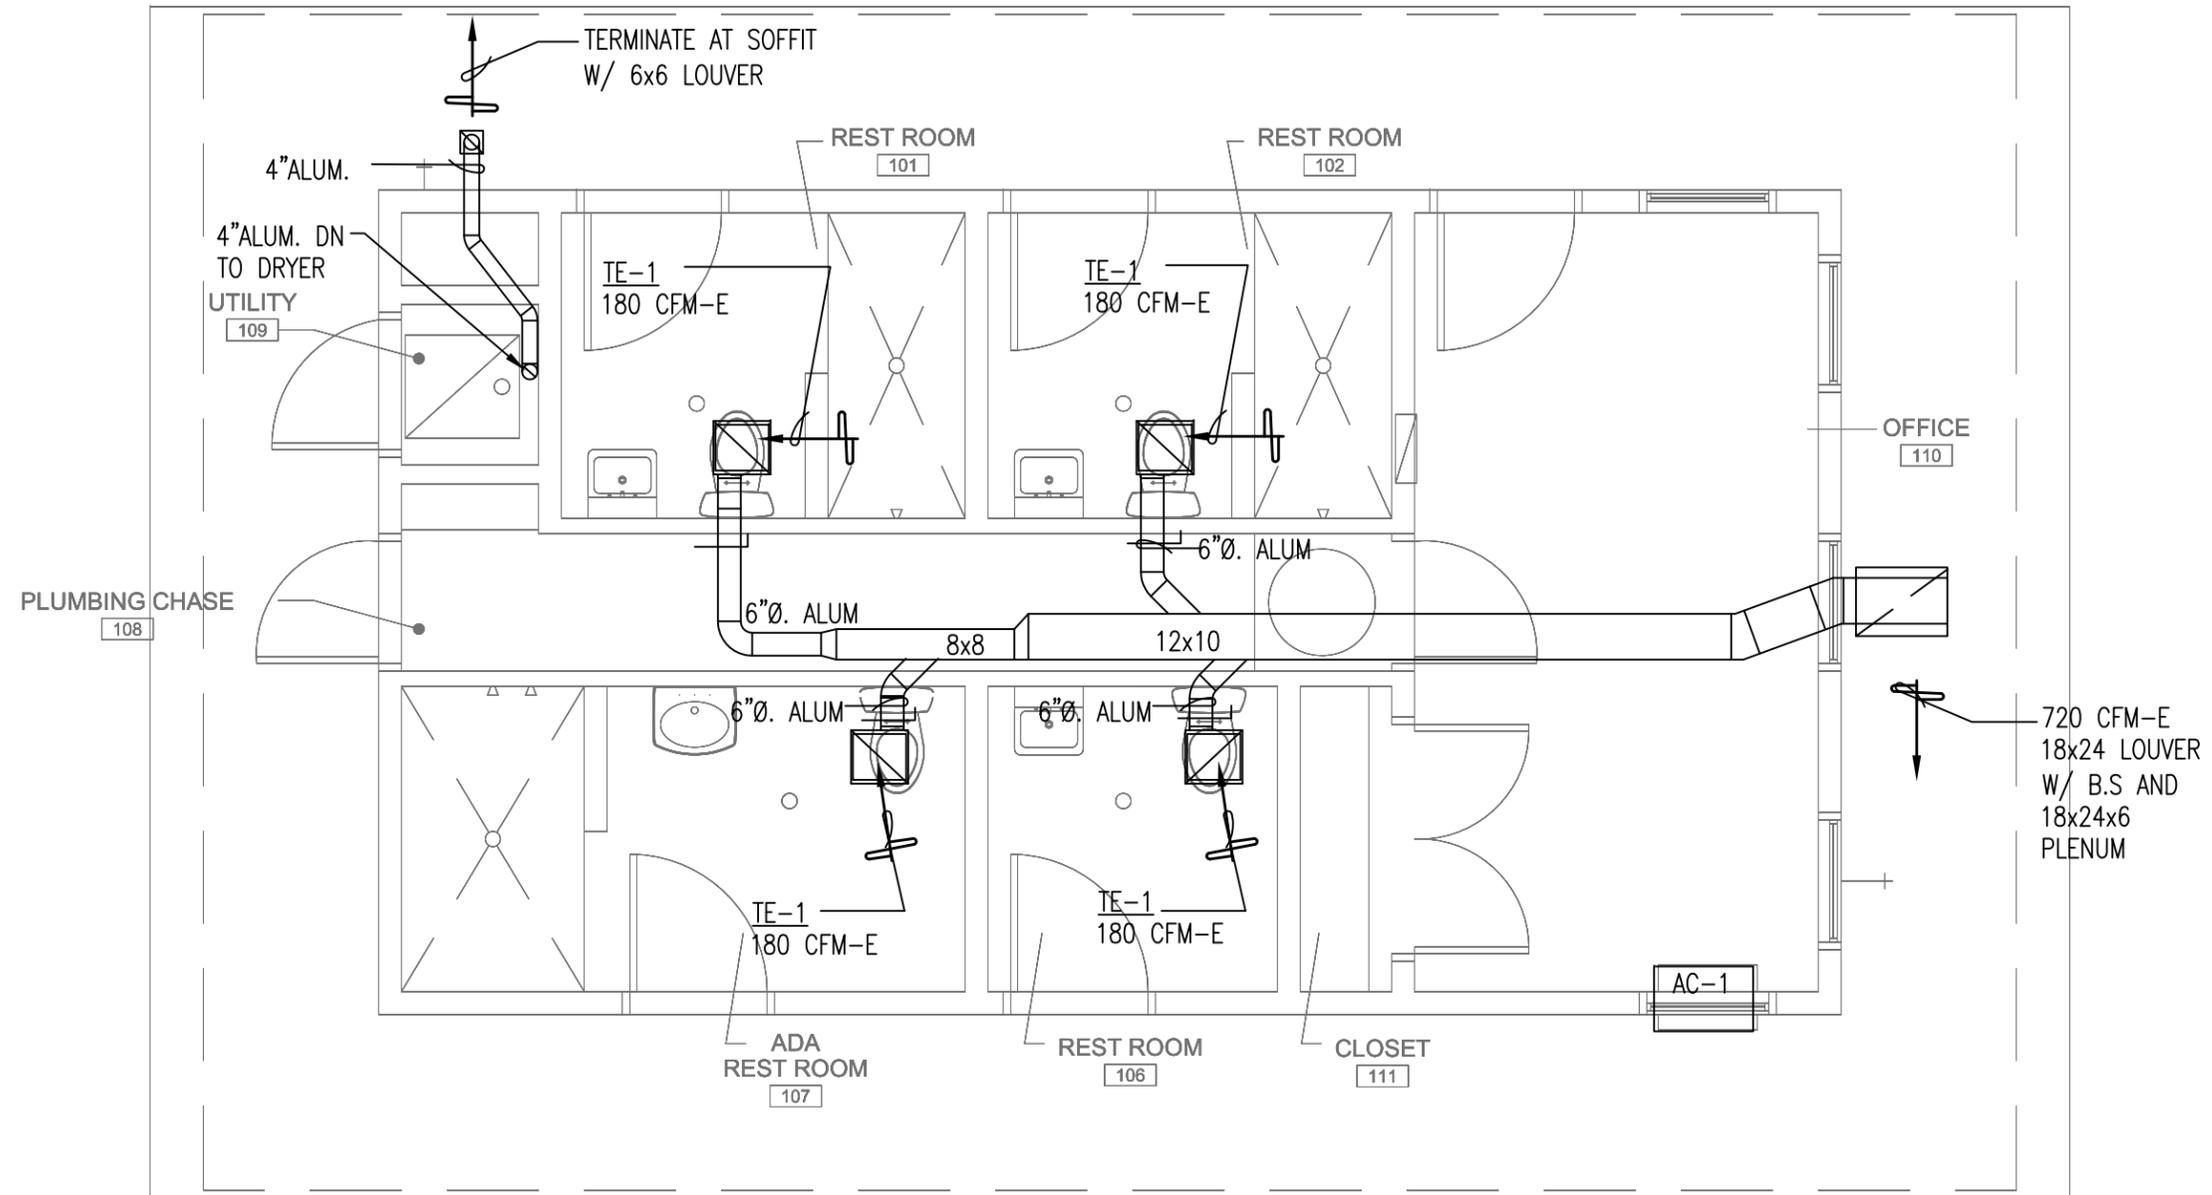
SHEET TITLE
MECHANICAL FLOOR PLAN

DRAWN: NAP	SHEET NO. M1-1
CHECKED: TS	
APPROVED: TS	
JOB NO. 10.09.10	

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PROJECT
WESTREC FLOATING WASHROOMS

SHEET TITLE
MECHANICAL FLOOR PLAN (JACKSON)

DRAWN: NAP	SHEET NO. M1-1J
CHECKED: TS	
APPROVED: TS	
JOB NO. 10.09.10	

EXHAUST FAN SCHEDULE

GREENHECK, CARNES, JENN-AIRE, OR COOK EQUAL FANS. (EQUAL SIZE, CFM, RPM, HP, SP, MATERIALS, CONTROLS, ETC.).

UNIT TAG	SERVICE	AIR VOLUME (CFM)	STATIC PRESSURE (INCH)	RPM	MOTOR HP/VOLT S/PHASE	DIMENSIONS/ DUCT/DAMPER (INCHES)	FAN TYPE	LOCATION	MODEL	CONTROLS
TE-1	BATHROOM	180	0.375	1100	2.2 AMPS	8H x 12W x 14L, 6 DIAM DUCT	CABINET CENTRIFUGAL	CEILING	GREENHECK SP-B200	1, 2

FAN CONTROLS

1	ON VIA MOTION DETECTOR AND/OR MANUAL ON/OFF SWITCH.
2	MANUAL ON/OFF SWITCH WITH ADJUSTABLE TIME DELAY SWITCH (5 TO 60 MINUTES).

OPTIONS AND ACCESSORIES:

1	UL/CUL 507 LISTED - "ELECTRIC FANS", EA VE ELBOW, ALUMINUM GRILLE WITH WHITE ENAMEL FINISH, MOTION DETECTOR, WALL MOUNTED, ISOLATION KIT, ALUMINUM WHEEL MATERIAL
---	---

GENERAL FAN NOTES

1	ALL FANS ARE FURNISHED AND INSTALLED BY MC. ALL STARTERS ARE FURNISHED BY MC AND INSTALLED BY EC. POWER WIRING IS BY EC AND CONTROL WIRING IS BY MC.
2	ALL FANS SHALL BE 120 VOLT, 1 PHASE AS NOTED AND AS VERIFIED IN THE FIELD . MODIFY THE FAN SUBMITTALS TO MATCH FIELD CONDITIONS. MECHANICAL CONTRACTOR DIRECT THE ELECTRICAL CONTRACTOR TO MODIFY THE POWER AND CONTROL CONNECTIONS AS PER THE FIELD CONDITIONS.
3	FOR EA VE DISCHARGE, PROVIDE LOUVER, GRAVITY DAMPER, INLET SCREEN GUARD, VIBRATION ISOLATION, AND SEAL WALL OPENINGS.

GRILLES REGISTERS AND DIFFUSERS

NOTES

NOTE: ALL DIFFUSERS, REGISTERS AND GRILLES SHALL HAVE FINISHES APPROVED BY THE ARCHITECT, FRAMES TO MATCH FLOOR, WALL AND CEILING FINISHES, MAXIMUM NOISE LEVELS OF NC-25 AND OPPOSED BLADE DAMPERS, UNLESS NOTED AS A GRILLE. EXACT REGISTER LOCATIONS, TYPES AND FINISHES SHALL BE APPROVED BY THE ARCHITECT PRIOR TO PURCHASE OR INSTALLATION.

PROVIDE ALUMINUM DIFFUSERS AND REGISTERS IN AREAS EXPOSED TO MOISTURE AND/OR CORROSION (TOILET ROOMS, KITCHENS, EXTERIOR, ETC.)

MANUFACTURERS:

CARNES, KRUEGER, PRICE, TITUS EQUAL MODELS.

GRILLE, REGISTER AND DIFFUSER TYPE	MODEL NO.	DESCRIPTION
LOUVERS	VENT PRODUCTS MODEL 4400 (4")	4 INCH DEEP STATIONARY BLADES, AT 30/40 DEGREE ANGLE; 18 GAUGE GALVANIZED STEEL, (.081) FRAME AND BLADES, WITH 1/2 X 1/2 INCH ALUMINUM SCREEN; FRAME TO MAKE OPENING REQUIREMENTS, INCLUDING SILL EXTENSION, SLEEVE, ETC. SIZE FOR ROUGH OPENING, PROVIDE WEATHER-SEAL TO ARCHITECTURAL OPENING, PROVIDE INSULATED, BLANK-OFF PANELS FOR UNUSED PORTIONS OF LOUVER.

HVAC NOTES

CITY OF CHICAGO REQUIREMENTS

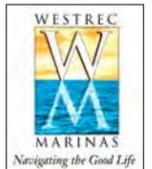
1	THE CONTRACTOR SHALL PROVIDE ALL PERMIT APPLICATION MATERIALS FOR THE CITY OF CHICAGO.
2	PROVIDE MINIMUM 15 FEET FROM OUTSIDE AIR INTAKES TO EXHAUST OUTLETS, PLUMBING VENTS, ETC.
3	ALL REGISTERS SHALL HAVE GRILLES WITH OPPOSED BLADE DAMPERS, UNLESS NOTED OTHERWISE.
4	ALL DUCTWORK SHALL BE RIGID, GALVANIZED STEEL, SHEET METAL AND SHALL MEET THE LATEST SMACNA CONSTRUCTION STANDARDS
5	LOCKING DAMPERS SHALL BE INSTALLED ON ALL WARM AIR RUNS.
6	NO FLEXIBLE DUCTWORK SHALL BE USED ON THIS PROJECT.
7	THERE SHALL BE NO REFRIGERATION FITTINGS, VALVES OR DEVICES IN THE AIR STREAM.
8	NOISE LEVEL FOR ALL HVAC EQUIPMENT SHALL NOT EXCEED 55 DBA (OR 62 DBA) AT THE LOT LINE AS PER CODE REQUIREMENTS.
9	TRANSFER DUCTS SHALL NOT EXCEED 5 FEET IN LENGTH.

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1	01/20/2011	SCHEMATIC DESIGN
NO	DATE	ISSUED FOR

PROJECT

WESTREC FLOATING WASHROOMS

SHEET TITLE

MECHANICAL SCHEDULES

DRAWN: NAP	SHEET NO.
CHECKED: TS	M2-1
APPROVED: TS	
JOB NO. 10.09.10	

CITY OF CHICAGO MECHANICAL NOTES

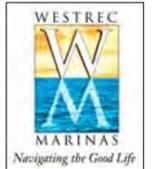
1	THE CONTRACTOR SHALL FOLLOW ALL HEATING, VENTILATING AND AIR CONDITIONING (HVAC) REGULATIONS OF THE CITY AND APPROVED VERSION OF CITY OF CHICAGO MECHANICAL CODE.
2	THE CONTRACTOR SHALL GUARANTEE ALL MATERIALS, DEVICES, EQUIPMENT, WORKMANSHIP AND THE SUCCESSFUL OPERATION OF ALL SYSTEMS AND APPARATUS INSTALLED FOR A PERIOD OF ONE YEAR FROM THE DATE OF FINAL ACCEPTANCE. SEE THE SPECIFICATIONS FOR DETAIL INTERPRETATION OF ALL INSTALLATION REQUIREMENTS.
3	THE CONTRACTOR SHALL FURNISH ALL MATERIALS, EQUIPMENT, AND LABOR NECESSARY FOR WORK TO EXISTING AND/OR NEW HEATING, VENTILATING AND AIR CONDITIONING SYSTEMS IN ACCORDANCE WITH ALL GOVERNING CODES, THE DRAWINGS, APPROVED SUBMITTALS, OWNER'S REQUIREMENTS AND AS SPECIFIED.
4	THE CONTRACTOR SHALL TAKE SUCH PROTECTIVE MEASURES AND PRECAUTIONS AS MAY BE REQUIRED OR NECESSARY TO PREVENT INJURY OR ACCIDENTS IN ACCORDANCE WITH THE PARTICULAR CONDITIONS AND OSHA REQUIREMENTS.
5	ALL POWER WIRING SHALL BE PROVIDED BY THE ELECTRICAL CONTRACTOR. THE CONTRACTOR SHALL PROVIDE ALL NECESSARY INFORMATION & DEVICES (INCLUDING STARTERS FOR MECHANICAL EQUIPMENT) FOR THE ELECTRICAL INSTALLATIONS.
6	CONTROL WIRING, DEVICES, ETC. SHALL BE PROVIDED BY THE CONTRACTOR. VERIFY ALL CONTROL AND SEQUENCE OF OPERATION NEEDS WITH THE OWNER.
7	THE CONTRACTOR SHALL SUPPLY ALL HANGERS AND SUPPORTS FOR HIS WORK.
8	THE DRAWINGS DO NOT DETAIL ALL FINAL CONNECTIONS TO EQUIPMENT. THE CONTRACTOR SHALL VERIFY SUCH CONNECTIONS PER THE MANUFACTURERS' SHOP DRAWINGS AND OTHER REQUIREMENTS.
9	LAYOUT IS DIAGRAMMATIC AND CONTRACTOR SHALL PROVIDE DESIGN BUILD BID PRICING FOR THE CONTROLS, DUCTWORK, AND NEW EXHAUST FANS. INSTALL EQUIPMENT, PIPING, AND DUCTWORK TO MEET FIELD CONDITIONS, AND PROVIDE SHOP DRAWINGS AS NECESSARY. EXACT LOCATION OF DUCTWORK, EQUIPMENT, GRILLES, AND REGISTERS SHALL BE APPROVED BY THE ARCHITECT WITH REFERENCE TO ANY LOCATIONS INDICATED. VERIFY ALL CONDITIONS, SUCH AS INTERIOR WALL SYSTEMS, ETC. WITH OTHER TRADES. COORDINATE ALL WORK WITH OTHER TRADES. MAINTAIN PROPER CLEARANCES AND HEADROOM AT THE EQUIPMENT AND DEVICES FOR INSPECTION AND SERVICE. CHANGE DIMENSIONS OF DUCTWORK WHEN REQUIRED TO MEET JOB CONDITIONS BUT MAINTAIN THE SAME EQUIVALENT CROSS SECTIONAL AREA. ALL DUCTWORK DIMENSIONS SHOWN ARE INSIDE. CLEAR MEASUREMENTS, MINIMUM CROSSSECTIONAL AREA,
10	ALL DUCTWORK, EXCEPT AS NOTED, SHALL BE CONSTRUCTED PER AIR DUCT DESIGN AND CONSTRUCTION STANDARDS OF ASHRAE, SMACNA AND LOCAL CODES. ALL DUCTS SHALL BE SMOOTH AND AIRTIGHT. TAPE ALL TRANSVERSE JOINTS DURING THE INSTALLATION.
11	ALL CONNECTIONS BETWEEN FANS AND DUCTWORK SHALL HAVE FIREPROOF, HEAVY-DUTY FLEXIBLE CONNECTIONS (UL AND LOCAL CODE OFFICIAL APPROVED) WITH A THREE INCH MINIMUM CLEARANCE. WEATHERPROOF AS REQUIRED.
12	THE CONTRACTOR SHALL TEST, BALANCE AND ADJUST ALL SYSTEMS AND PLACE IN PROPER OPERATION (WITHIN 5 PERCENT OF DESIGN RATINGS) AS PER THE SPECIFICATIONS AND INDUSTRY STANDARDS. PROVIDE BALANCE REPORTS AS PER NEBB STANDARDS. COMFORT BALANCE MULTIPLE TIMES, AND SEASONALLY, IF NECESSARY TO THE USERS SATISFACTION.
13	ALL DUCTWORK AND PIPING SHALL RUN CONCEALED IN WALLS, JOIST SPACES AND/OR IN CEILING SPACES. WHEN PIPING OR DUCTWORK IS REQUIRED TO BE EXPOSED, IT MUST RUN PARALLEL TO STRUCTURAL MEMBER OR EXACTLY PERPENDICULAR TO STRUCTURE. RUN AS OBSCURE AS POSSIBLE AS DIRECTED BY ARCHITECT.
14	MECHANICAL EQUIPMENT SHALL BE LOCATED AND INSTALLED TO PREVENT TRANSMISSION OF OBJECTIONABLE SOUND.
15	ALL EXHAUST AND OTHER EXTERIOR PENETRATIONS SHALL BE INSTALLED TO AVOID CONDENSATION BUILD-UP, AND SNOW OR RAIN PENETRATION.
16	ALL PIPING AND DUCTWORK TO BE SUSPENDED FROM STRUCTURAL MEMBERS OF BUILDING, AS APPROVED BY ARCHITECT REPRESENTATIVE.
17	COMPLETE EQUIPMENT AND INSTALLATION SHOP DRAWINGS SHALL BE FURNISHED AND REVIEWED PRIOR TO ANY CONSTRUCTION. REFER TO AIA 201 DOCUMENTS INCLUDING GENERAL CONDITIONS OF THE CONTRACT FOR CONSTRUCTION (1997 EDITION) FOR SUBMITTAL AND OTHER CONTRACT ADMINISTRATION PROVISIONS.
18	MAINTAIN AS-BUILT SET OF CONTRACT DRAWINGS ON ALL WORK AS INSTALLED, SHOWING SIZE AND LOCATION CHANGES. GIVE REFERENCE DIMENSIONS FOR THE LOCATION OF ANY CONCEALED ITEMS REQUIRING ADJUSTMENT, INSPECTION, SERVICE OR REPLACEMENT. DRAWING BACKGROUNDS SHALL BE FURNISHED TO THE CONTRACTOR BY THE ARCHITECT IF NEEDED. PROVIDE COMPLETE OPERATION AND MAINTENANCE MANUALS, WRITTEN AND VERBAL INSTRUCTIONS, GUARANTEES AND WARRANTIES, WRITTEN VERIFICATION THAT ALL PUNCH-LISTS ARE COMPLETE AND OTHER CLOSE-OUT WORK AND DOCUMENTATION PRIOR TO FINAL PAYMENTS.
19	PROVIDE AT LEAST TWO (ONE PER SEASON), NON-EMERGENCY SITE VISITS DURING THE ONE YEAR WARRANTY PERIOD TO ADJUST EQUIPMENT AND EXAMINE THE SYSTEM OPERATIONS. ADDITIONAL SITE VISITS WILL BE REQUIRE IF WARRANTIED EQUIPMENT NEEDS REPAIR OR REPLACEMENT.

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PROJECT
WESTREC FLOATING WASHROOMS

SHEET TITLE
MECHANICAL SCHEDULES

DRAWN: NAP	SHEET NO.
CHECKED: TS	M2-2
APPROVED: TS	
JOB NO. 10.09.10	

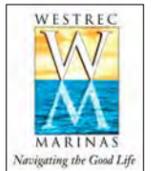
VENTILATION SCHEDULE - PUBLIC AREA

Room Number	Room Name (Plan)	Room Purpose (per Table 403.3)	Floor Area	Ordinance Requirements								Actual Provided				Equipment		Remarks
				Natural Light & Vent (SF)		Mechanical Ventilation (CFM/SF)		Mechanical Ventilation (CFM)		(RO) Relief Openings Req'm'ts	Natural Light & Vent (SF)		Mechanical Ventilation (CFM)		Tag of equipment: supplying air to the room	Tag of equipment ex-hausting air from the rm		
				See Window schedule on Arch Sheet		Supply Air (from room)	Exhaust Air (from room)	Supply Air (from room)	Exhaust Air (from room)		Volume (CFM)	Area of Duct (SF)	Glass Area	Vent Area			Supply Air (from room)	
101	RESTROOM	TOILET	59	NR	NR	0	2	0	118	NR	NR	0	0	0	180		TE-1	
102	RESTROOM	TOILET	59	NR	NR	0	2	0	118	NR	NR	0	0	0	180		TE-1	
103	RESTROOM	TOILET	59	NR	NR	0	2	0	118	NR	NR	0	0	0	180		TE-1	
104	ELECTRICAL CLOSET	INACTIVE STORAGE	59	NR	NR	0	2	0	118	NR	NR	0	0	0	0		TE-1	
105	RESTROOM	TOILET	59	NR	NR	0	2	0	118	NR	NR	0	0	0	180		TE-1	
106	RESTROOM	TOILET	59	NR	NR	0	2	0	118	NR	NR	0	0	0	180		TE-1	
107	RESTROOM	TOILET	82	NR	NR	0	2	0	164	NR	NR	0	0	0	180		TE-1	
108	UTILITY	INACTIVE STORAGE	16	NR	NR	0	0	0	0	NR	NR	0	0	0	0			
			452												0	1080		

VENTILATION SCHEDULE - PUBLIC AREA (JACKSON)

Room Number	Room Name (Plan)	Room Purpose (per Table 403.3)	Floor Area	Ordinance Requirements								Actual Provided				Equipment		Remarks
				Natural Light & Vent (SF)		Mechanical Ventilation (CFM/SF)		Mechanical Ventilation (CFM)		(RO) Relief Openings Req'm'ts	Natural Light & Vent (SF)		Mechanical Ventilation (CFM)		Tag of equipment: supplying air to the room	Tag of equipment ex-hausting air from the rm		
				See Window schedule on Arch Sheet		Supply Air (from room)	Exhaust Air (from room)	Supply Air (from room)	Exhaust Air (from room)		Volume (CFM)	Area of Duct (SF)	Glass Area	Vent Area			Supply Air (from room)	
101	RESTROOM	TOILET	59	NR	NR	0	2	0	118	NR	NR	0	0	0	180		TE-1	
102	RESTROOM	TOILET	59	NR	NR	0	2	0	118	NR	NR	0	0	0	180		TE-1	
106	RESTROOM	TOILET	35	NR	NR	0	2	0	70	NR	NR	0	0	0	180		TE-1	
107	RESTROOM	TOILET	82	NR	NR	0	2	0	164	NR	NR	0	0	0	0		TE-1	
109	UTILITY	INACTIVE STORAGE	16	NR	NR	0	0	0	0	NR	NR	0	0	0	0			
110	OFFICE	OFFICE	150	120	60	0	0	0	0	NR	NR	37.6	18.8	0	180		TE-1	
111	CLOSET	INACTIVE STORAGE	20	NR	NR	0	0	0	0	NR	NR	0	0	0	0			
			421												0	720		

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1	01/20/2011	SCHEMATIC DESIGN
NO	DATE	ISSUED FOR

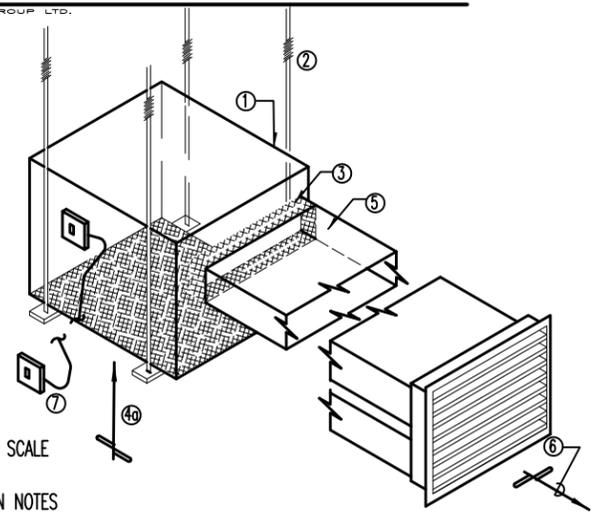
PROJECT
WESTREC FLOATING WASHROOMS

SHEET TITLE
MECHANICAL SCHEDULES

DRAWN: NAP	M2-3
CHECKED: TS	
APPROVED: TS	
JOB NO. 10.09.10	

CEILING CABINET EXHAUST FAN DETAIL

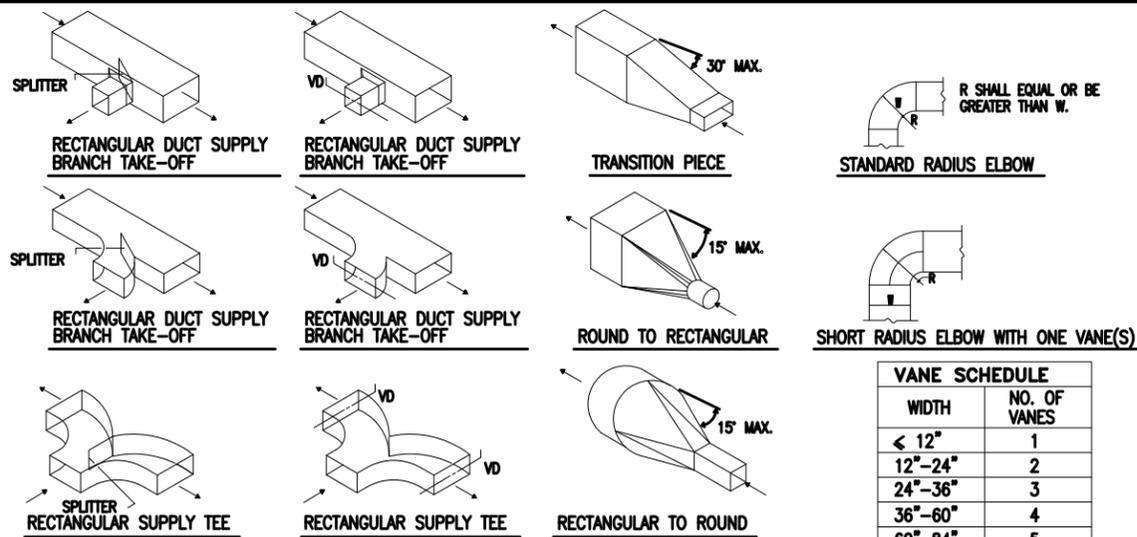
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DETAIL IS NOT TO SCALE

CABINET EXHAUST FAN NOTES

1. CABINET EXHAUST FAN; MODIFY LAYOUT FOR VERTICAL OR OTHER TYPE OF FAN ARRANGEMENT AND/OR DUCT CONNECTIONS. ALL INLINE AND/OR CEILING-MOUNTED CABINET EXHAUST FANS SHALL HAVE A MINIMUM OF 1/2" INSULATED LINING, GRAVITY BACK DRAFT DAMPER, & U.L. LISTING.
2. MOUNT CABINET EXHAUST FAN IN AT LEAST 4 POINTS AND WITH VIBRATION ISOLATION MOUNTS.
3. PROVIDE FLEXIBLE DUCT CONNECTIONS AT DUCT INLET AND OUTLET.
4. EXHAUST INLET IN ONE OF TWO METHODS:
 - A. CEILING-GRILLE FAN CONFIGURATION WITH FULL CABINET AREA, EXHAUST GRILLE WITH INLET FILTER AND/OR FIRE DAMPER AS SPECIFIED OR OTHERWISE REQUIRED.
5. OUTLET DUCTWORK TO MATCH FIELD CONDITIONS; HORIZONTAL OR VERTICAL, RECTANGULAR OR ROUND DUCT FITTINGS.
6. EXHAUST DISCHARGE SHALL HAVE A GRAVITY BACK DRAFT DAMPER AND BIRD SCREEN AT EXTERIOR OUTLET; DISCHARGE METHOD SHALL BE AS FOLLOWS:
 - A. LOUVER, WEATHERPROOF-TYPE, MOUNTED FLUSH TO EXTERIOR SURFACE ONE OR MULTIPLY DUCT CONNECTIONS, PROVIDE INSULATED BLANK-OFF OF UNUSED PORTIONS OF THE LOUVER INLET;
7. PROVIDE CABINET EXHAUST FAN MOUNTED CODE DISCONNECT SWITCH; CONNECTED TO REMOTE MOUNTED CONTROL SWITCH AS SPECIFIED OR AS IS REQUIRED BY ACTUAL APPLICATION; LOCAL FAN CONTROL MOUNTED NEAR EXHAUST INLET SHALL BE BY ONE OF THE FOLLOWING METHODS:
 - A. SEPARATE, LOCAL ON/OFF SWITCH WITH PILOT LIGHT;
8. PROVIDE ACCESS PANEL AS REQUIRED FOR SERVICING WITH CLEARANCES FOR THE FAN, MOTOR & ELECTRICAL CONNECTIONS.
9. ALL FANS SHALL BE 120 VOLT, SINGLE PHASE UNLESS NOTED OTHERWISE. ALL FANS & CONTROL DEVICES SHALL BE FURNISHED AND INSTALLED BY THE MECHANICAL CONTRACTOR. ALL WIRING IS BY ELECTRICAL CONTRACTOR.



TYPICAL DUCT DETAILS

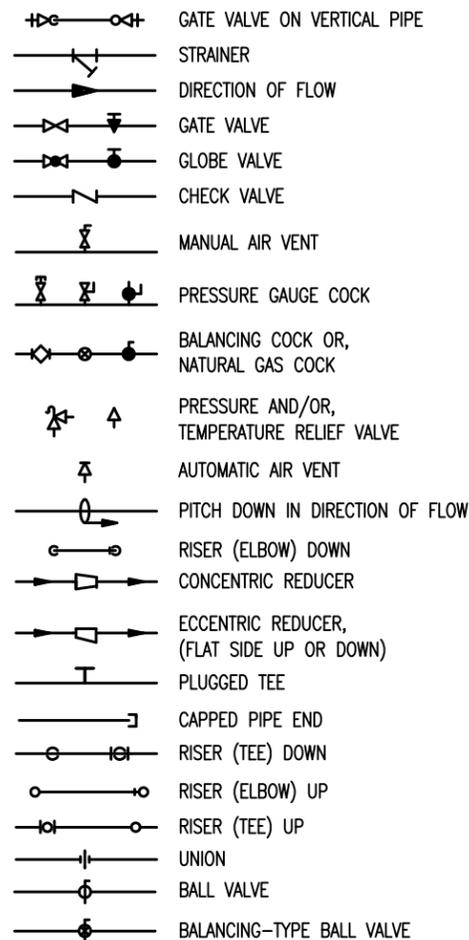
NOT TO SCALE

MECHANICAL SYMBOL LIST

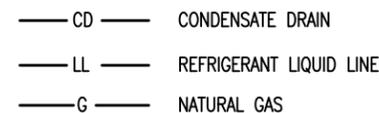
NOTE: NOT ALL SYMBOLS ARE APPLICABLE TO THIS PROJECT

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PIPE FITTINGS



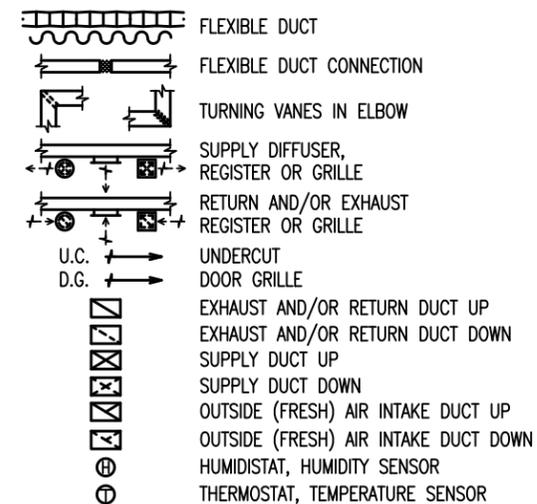
PIPE SERVICE TAGS



ABBREVIATIONS

ACD	ACCESS DOOR
AD	AUTOMATIC DAMPER
AFF	ABOVE FINISHED FLOOR
BI	BLACK IRON
BO	BLANK OFF
BS	BIRD SCREEN
CFM	CUBIC FEET PER MINUTE
CFM-E	CUBIC FEET PER MINUTE-EXHAUST
CFM-ER	CUBIC FEET PER MINUTE-EXHAUST/RETURN
CFM-R	CUBIC FEET PER MINUTE-RETURN
CFM-S	CUBIC FEET PER MINUTE-SUPPLY
DIFF	DIFFUSER
DN	DOWN
EA	EACH
EA EXH	EXHAUST AIR
FAI	FRESH AIR INTAKE
FD	FIRE DAMPER
GA	GAUGE
GC	GENERAL CONTRACTOR
G	NATURAL GAS
GR	GRILLE
MD	MANUAL DAMPER
NIC	NOT IN CONTRACT
NK	NECK
OA	OUTSIDE AIR
OAI	OUTSIDE AIR INTAKE
RA/RET	RETURN AIR
RAD	RADIATION
REG	REGISTER
SA/SUP	SUPPLY AIR
SQ. FT	SQUARE FEET
TC	TEMPERATURE CONTROL
TYP	TYPICAL
VIF	VERIFY IN FIELD

VENTILATION



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NO	DATE	ISSUED FOR

PROJECT

WESTREC FLOATING WASHROOMS

SHEET TITLE

MECHANICAL DETAILS

DRAWN: NAP

CHECKED: TS

APPROVED: TS

JOB NO. 10.09.10

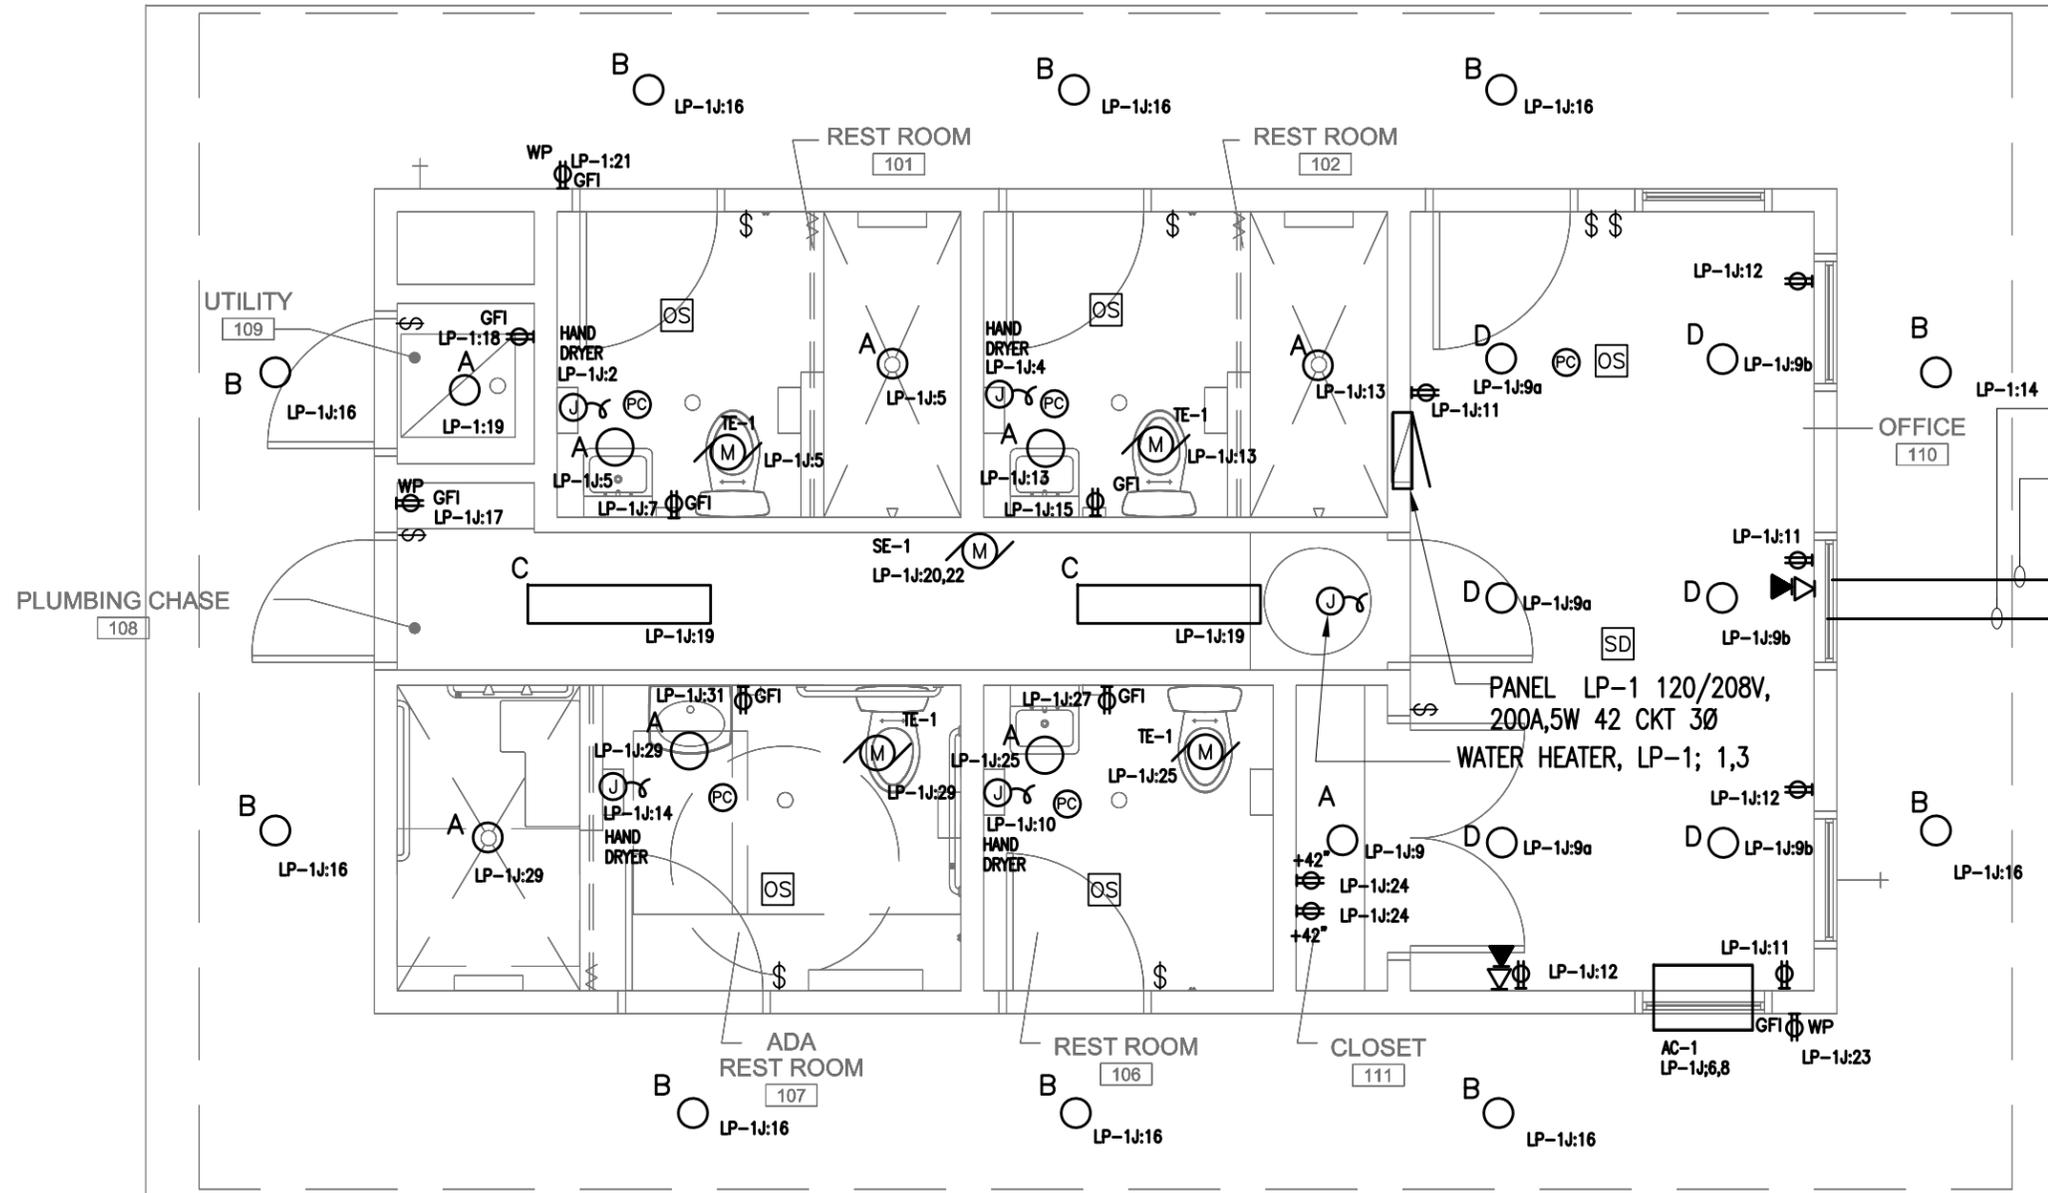
SHEET NO.

M3-1

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5 #2/0 AWG Cu. 2-1/2" C
1 #6 AWG Cu., 1/2" C. TO SUPPLEMENTAL GROUNDING
SEE SITE PLAN FOR UTILITY CONNECTION DETAILS

NOTE:
ROUTE CONDUIT HORIZONTALLY FROM THE PLUMBING CHASE THROUGH ADJACENT WALLS TO ALL DEVICES ON EXTERIOR WALLS. DO NOT ROUTE CONDUIT FROM OVERHEAD BETWEEN THE PERFORATED ALUMINUM PANELS.

1 ELECTRICAL PLAN
SCALE: 1/4" = 1'-0"

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PROJECT
WESTREC FLOATING WASHROOMS

SHEET TITLE
ELECTRICAL FLOOR PLAN (JACKSON)

DRAWN: NAP	SHEET NO.
CHECKED: TS	E1-1J
APPROVED: TS	
JOB NO. 10.09.10	

LIGHTING FIXTURE SCHEDULE

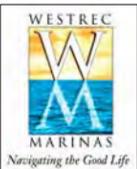
TAG	LOCATION	MANUFACTURER MODEL NO.	LAMPS	MOUNTING	DESCRIPTION
A	INTERIOR BATH ROOM CEILING	SPECTRUM SP5VF 1 32 EX 120	(1) 32W VERTICAL CFL	RECESSED CEILING, REGRESSED BAFFLED LENS	5 INCH DIAMETER, WHITE TRIM, PRISMATIC GLASS LENS, ELECTRONIC BALLAST, SERVICEABLE THRU APERTURE
B	EXTERIOR SOFFIT CEILING	SPECTRUM SP7MH 50 EX 120, 7135 WS PG WL	(1) 50 W MH CLEAR, ED-17	RECESSED CEILING, REGRESSED BAFFLED LENS	7 INCH DIAMETER, WHITE TRIM, PRISMATIC GLASS LENS, ELECTRONIC BALLAST, SERVICEABLE THRU APERTURE, WET LOCATION, COLD WEATHER BALLAST. 7 INCH HIGH.
C	INTERIOR UTILITY CHASE	DAY BRITE 2D 232RA21	(2) F32/ T8/ 835/ 3500K	SURFACE CEILING, 8"-0" ABOVE FINISHED FLOOR	2 LAMP FLUORSCENT, WRAP AROUND, ELECTRONIC BALLAST, MOUNTED TO STRUCTURE ON CEILING SURFACE OR SUSPENDED ON CHAINS
D	INTERIOR OFFICE CEILING	SPECTRUM SP5VF 1 32 EX 120	(1) 32W VERTICAL CFL	RECESSED CEILING, REGRESSED BAFFLED LENS	5 INCH DIAMETER, WHITE TRIM, PRISMATIC GLASS LENS, ELECTRONIC BALLAST, SERVICEABLE THRU APERTURE

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NO	DATE	ISSUED FOR

PROJECT

**WESTREC FLOATING
WASHROOMS**

SHEET TITLE

**ELECTRICAL
SCHEDULES**

DRAWN: NAP

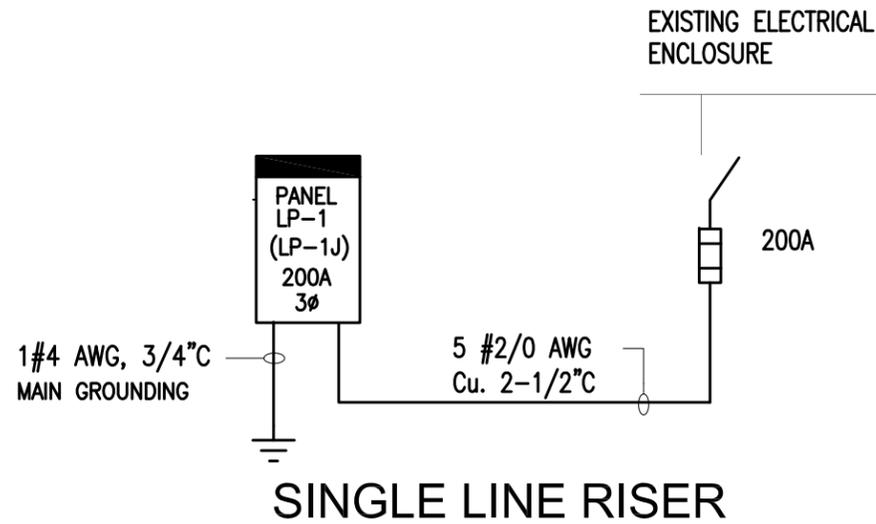
CHECKED: TS

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JOB NO. 10.09.10

SHEET NO.

E2-1



SCALE: N.T.S.

EQUIPMENT CONNECTION NOTES

1. VERIFY FINAL LOCATION OF ALL EQUIPMENT WITH EQUIPMENT INSTALLER BEFORE INSTALLING FEEDERS.
2. SEE ARCHITECTURAL, MECHANICAL AND PLUMBING DRAWINGS FOR MORE INFORMATION.
3. SIZE STARTER/FEEDER DISCONNECT PER FINAL EQUIPMENT REQUIREMENTS.
4. PROVIDE OVERLOAD PROTECTION (FUSES OR MOTOR CIRCUIT PROTECTOR) PER SPECIFICATIONS, ACTUAL FIELD MEASURED 5. FULL LOAD CURRENT, AND EQUIPMENT MANUFACTURER'S REQUIREMENTS.
6. VERIFY FINAL VOLTAGE AND PHASE REQUIREMENTS OF ALL EQUIPMENT WITH INSTALLER BEFORE INSTALLING FEEDERS.
7. COORDINATE SHORT CIRCUIT OCD RATING WITH FINAL EQUIPMENT REQUIREMENTS
8. PROVIDE LOCAL DISCONNECT WITHIN 5' OF EQUIPMENT.

ELECTRICAL LOAD CENTER NOTES
THE PANEL SCHEDULES ARE TO BE COMPLETED BY THE CONTRACTOR AND PLACED IN PANEL DOOR

REFER TO MECHANICAL PLANS FOR SIZES OF OCD'S FOR MECHANICAL EQUIPMENT

- ALL CIRCUITS MIN. 2#12AWG, #12AWG. GRD Cu
- 30A CIRCUITS MIN. 2#10AWG. #12AWG. GRD Cu.
- 40A CIRCUITS MIN. 2#8 AWG, #10AWG. GRD Cu
- 60A CIRCUITS MIN. 2#6 AWG, #19AWG, GRD Cu.

INCREASE BRANCH CIRCUIT CONDUCTORS BY ONE SIZE FOR ALL BRANCH CIRCUITS OVER 100'-0"

PANEL: LP-1 120/208V 3φ 5 WIRE RECESSED MOUNTED BUS 200 AMPS
LOCATION: ELECTRICAL ROOM MAIN BREAKER: 200 AMPS

CCT NO.	VOLT-AMPERES			DESCRIPTION	EQUIP	RECEPT	LIGHT	POLE	AMPS	PHASE			AMPS	POLE	LIGHT	RECEPT	EQUIP	DESCRIPTION	VOLT-AMPERES			CCT NO.
	φA	φB	φC							A	B	C							φA	φB	φC	
1				WATER HEATER					60				20	1				HAND DRYERS				2
3								2					20	1				HAND DRYERS				4
5				RESTROOM 101	✓	✓		1	20				20	1			✓	HAND DRYERS				6
7				RESTROOM 101				1	20				20	1			✓	HAND DRYERS				8
9				RESTROOM 102	✓	✓		1	20				20	1			✓	HAND DRYERS				10
11				RESTROOM 102				1	20				20	1			✓	HAND DRYERS				12
13				RESTROOM 103	✓	✓		1	20				20	1			✓	OUTDOOR LTG				14
15				RESTROOM 103				1	20				20	1			✓	WASHMACHINE				16
17				RECEPTACLES 108	✓			1	20				20				✓	SE-1				16
19				CHASE 108				1	20				2									20
21				OUTDOOR RECEPT	✓			1	20				20	1			✓	RESTROOM 107				22
23				OUTDOOR RECEPT	✓			1	20				20	1			✓	RESTROOM 107				24
25				SPARE				1	20				20	1			✓	RESTROOM 106				26
27				SPARE				1	20				20	1			✓	RESTROOM 106				28
29				SPACE									20	1			✓	RESTROOM 105				30
31				SPACE									20	1			✓	RESTROOM 105				32
33				SPACE									20	1				SPACE				34
35				SPACE														SPACE				36
37				SPACE														SPACE				36
39				SPACE														SPACE				40
41				SPACE														SPACE				42

PANEL: LP-1J 120/208V 3φ 5 WIRE RECESSED MOUNTED BUS 200 AMPS
LOCATION: ELECTRICAL ROOM MAIN BREAKER: 200 AMPS

CCT NO.	VOLT-AMPERES			DESCRIPTION	EQUIP	RECEPT	LIGHT	POLE	AMPS	PHASE			AMPS	POLE	LIGHT	RECEPT	EQUIP	DESCRIPTION	VOLT-AMPERES			CCT NO.
	φA	φB	φC							A	B	C							φA	φB	φC	
1				WATER HEATER					60				20	1				HAND DRYERS				2
3								2					20	1				HAND DRYERS				4
5				RESTROOM 101	✓	✓		1	20				20				✓	AC-1				6
7				RESTROOM 101				1	20				2									8
9				OFFICE 110				1	20				20	1			✓	HAND DRYERS				10
11				OFFICE 110				1	20				20	1			✓	OFFICE 110				12
13				RESTROOM 102	✓	✓		1	20				20	1			✓	HAND DRYERS				14
15				RESTROOM 102				1	20				20	1			✓	OUTDOOR LTG				16
17				RECEPTACLES 108	✓			1	20				20	1			✓	WASHMACHINE				18
19				CHASE 108				1	20				20				✓	SE-1				20
21				OUTDOOR RECEPT	✓			1	20				2									22
23				OUTDOOR RECEPT	✓			1	20				20	1			✓	OFFICE 110				24
25				RESTROOM 106	✓	✓		1	20				20	1				SPACE				26
27				RESTROOM 106				1	20									SPACE				28
29				RESTROOM 107	✓	✓		1	20									SPACE				30
31				RESTROOM 107				1	20									SPACE				32
33				SPACE														SPACE				34
35				SPACE														SPACE				36
37				SPACE														SPACE				36
39				SPACE														SPACE				40
41				SPACE														SPACE				42

* PHOTOCELL CONTROL

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WESTREC MARINAS
Navigating the Good Life

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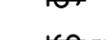
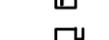
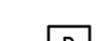
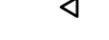
PROJECT
WESTREC FLOATING WASHROOMS

SHEET TITLE
ELECTRICAL RISER

DRAWN: NAP	SHEET NO.
CHECKED: TS	E3-1
APPROVED: TS	
JOB NO. 10.09.10	

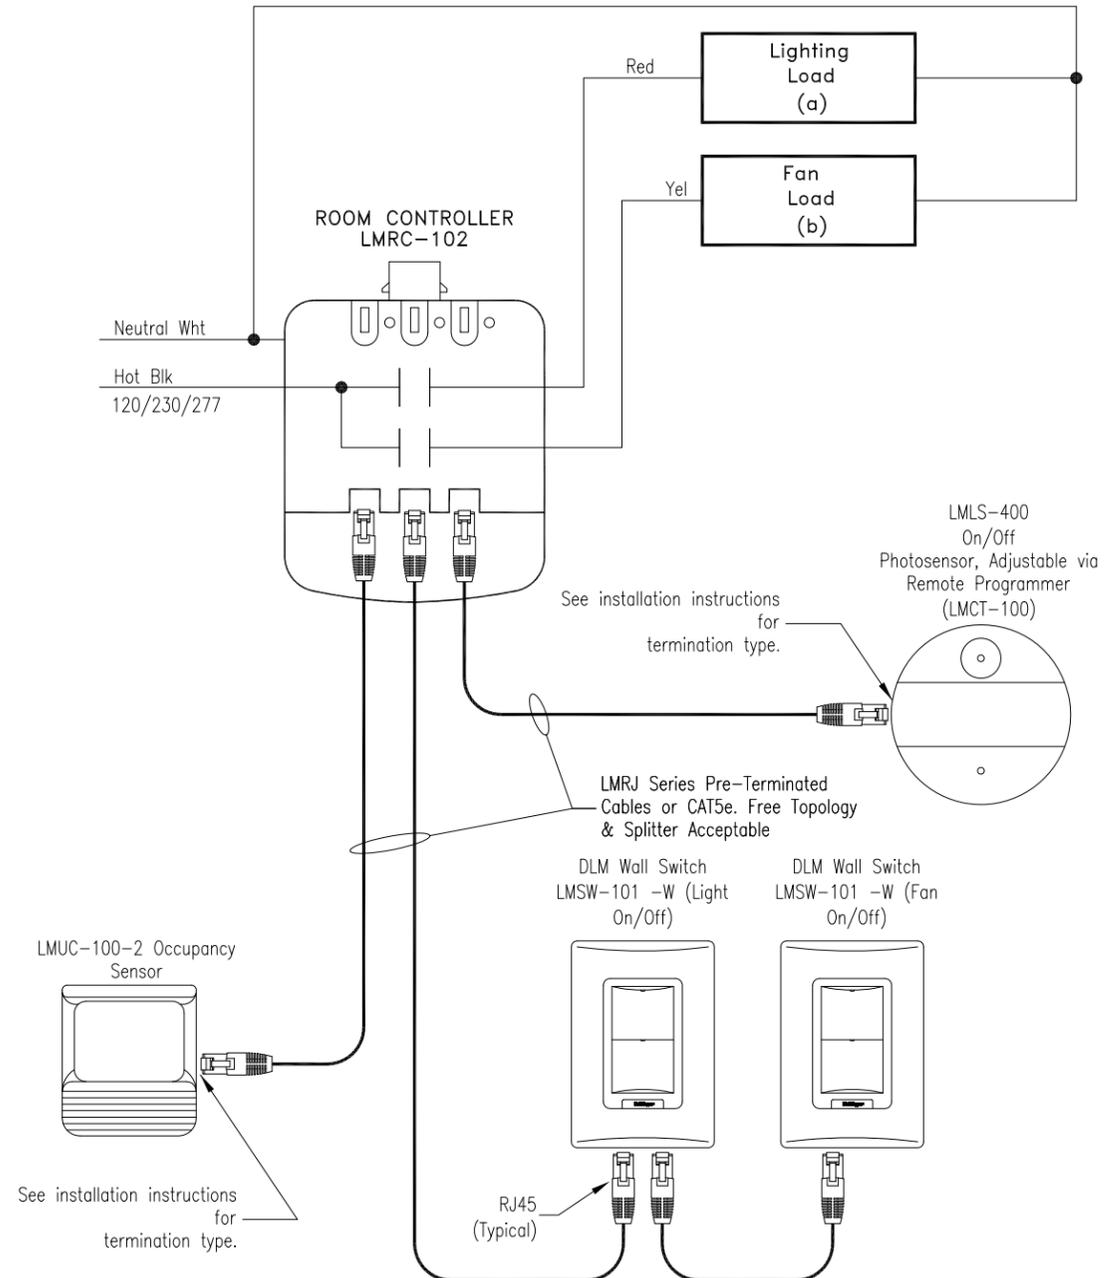
ELECTRICAL SYMBOL LIST

SYMBOLS

	LIGHTING FIXTURE FOR DESCRIPTION SEE LIGHTING FIXTURE SCHEDULE
	JUNCTION BOX
	CONDUIT-CONCEALED ABOVE CEILING OR IN WALL
	CONDUIT-CONCEALED IN FLOOR OR IN CEILING BELOW
	CONDUIT-EXPOSED
	CONDUIT-FLEXIBLE
	SINGLE POLE SWITCH 48" MTG. HT.
	THREE-WAY SWITCH 48" MTG. HT.
	DUPLEX GRD. RECEPTACLE 12" MTG. HT.
	FLOOR MTD DUPLEX GRD. RECEPTACLE 12" MTG. HT.
	MOTOR
	FUSED SAFETY SWITCH
	NON-FUSED DISCONNECT SWITCH
	LIGHTING AND RECEPTACLE PANELBOARD,
	SMOKE DETECTOR
	HEAT DETECTOR
	TELEPHONE OUTLET BOX & CONDUIT SYSTEM, BY E.C. 3/4" C UP TO CEILING
	DATA OUTLET BOX, COVER PLATE AND 3/4" C. STUB INTO CEILING SPACE FOR FUTURE DATA USE
	PHOTOCELL

ABBREVIATIONS

A, AMP	AMPERAGE
ACD	ACCESS DOOR
AFF	ABOVE FINISHED FLOOR
BO	BLANK OFF
CECO	COMMONWEALTH EDISON COMPANY
DN	DOWN
EA	EACH
EC	ELECTRICAL CONTRACTOR
FBO	FURNISHED BY OTHERS
GA	GAUGE
GC	GENERAL CONTRACTOR
GFI	GROUND FAULT INTERRUPTER
HP	HORSE-POWER
MC	MECHANICAL CONTRACTOR
NIC	NOT IN CONTACT
PC	PLUMBING CONTRACTOR
PS	PUBLIC SERVICE
TC	TEMPERATURE CONTROL
TTC	TELEPHONE TERMINAL CABINET
TYP	TYPICAL
V	VOLT
VIF	VERIFY IN FIELD
W	WATT
WP	WEATHER-PROOF.(NEMA 3R)
EX	EXISTING TO REMAIN
REL	RELOCATE
REM	REMOVE
REF	REFRIGERATOR



DEVICES ARE PRESET FOR PLUG n' GO™ OPERATION, with field adjustments.
 Sequence of Operation: When ambient light levels exceed the off setpoint, the Photosensor turns Lighting Load (a) off. It will turn connected Lighting Load (a) back on when the on setpoint is triggered. The Occupancy Sensor shall turn on the Lighting Load and Fan Load and will remain on for additional 10 minutes (adjustable). The wall switches shall turn on the each load for the time setting for the occupancy sensor (10 minutes adjustable). The products are based on the Watt Stopper DLM System.

Daylighting On/Off Photosensor with 2-relay Room Controller and Occupancy Sensor - Washroom controls

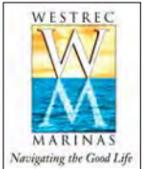
SCALE: N.T.S.

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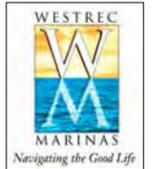
5	07/18/2011	ISSUE FOR BID
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1	01/20/2011	SCHEMATIC DESIGN
NO	DATE	ISSUED FOR

PROJECT
WESTREC FLOATING WASHROOMS

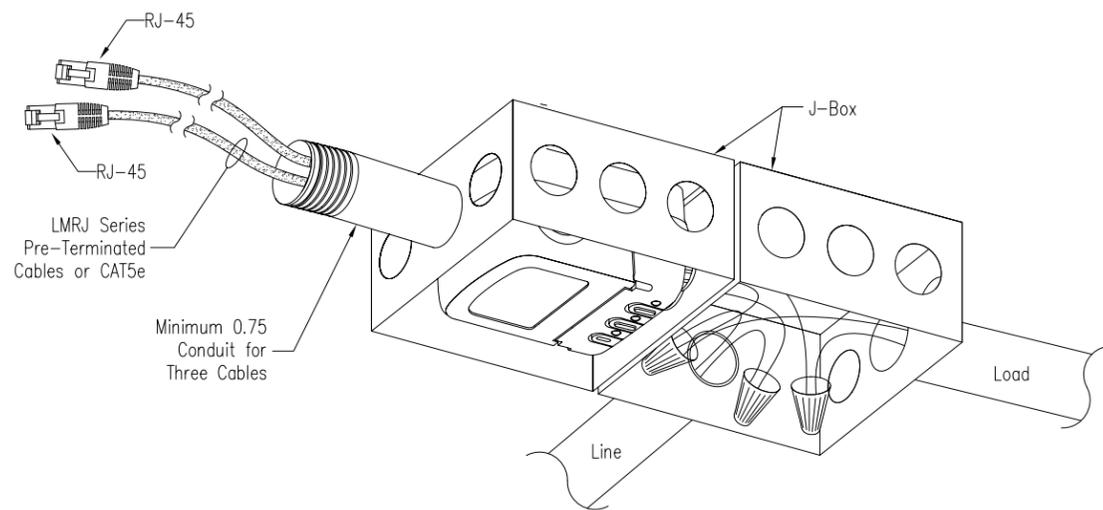
SHEET TITLE
ELECTRICAL DETAILS

DRAWN: NAP	SHEET NO.
CHECKED: TS	E3-2
APPROVED: TS	
JOB NO. 10.09.10	

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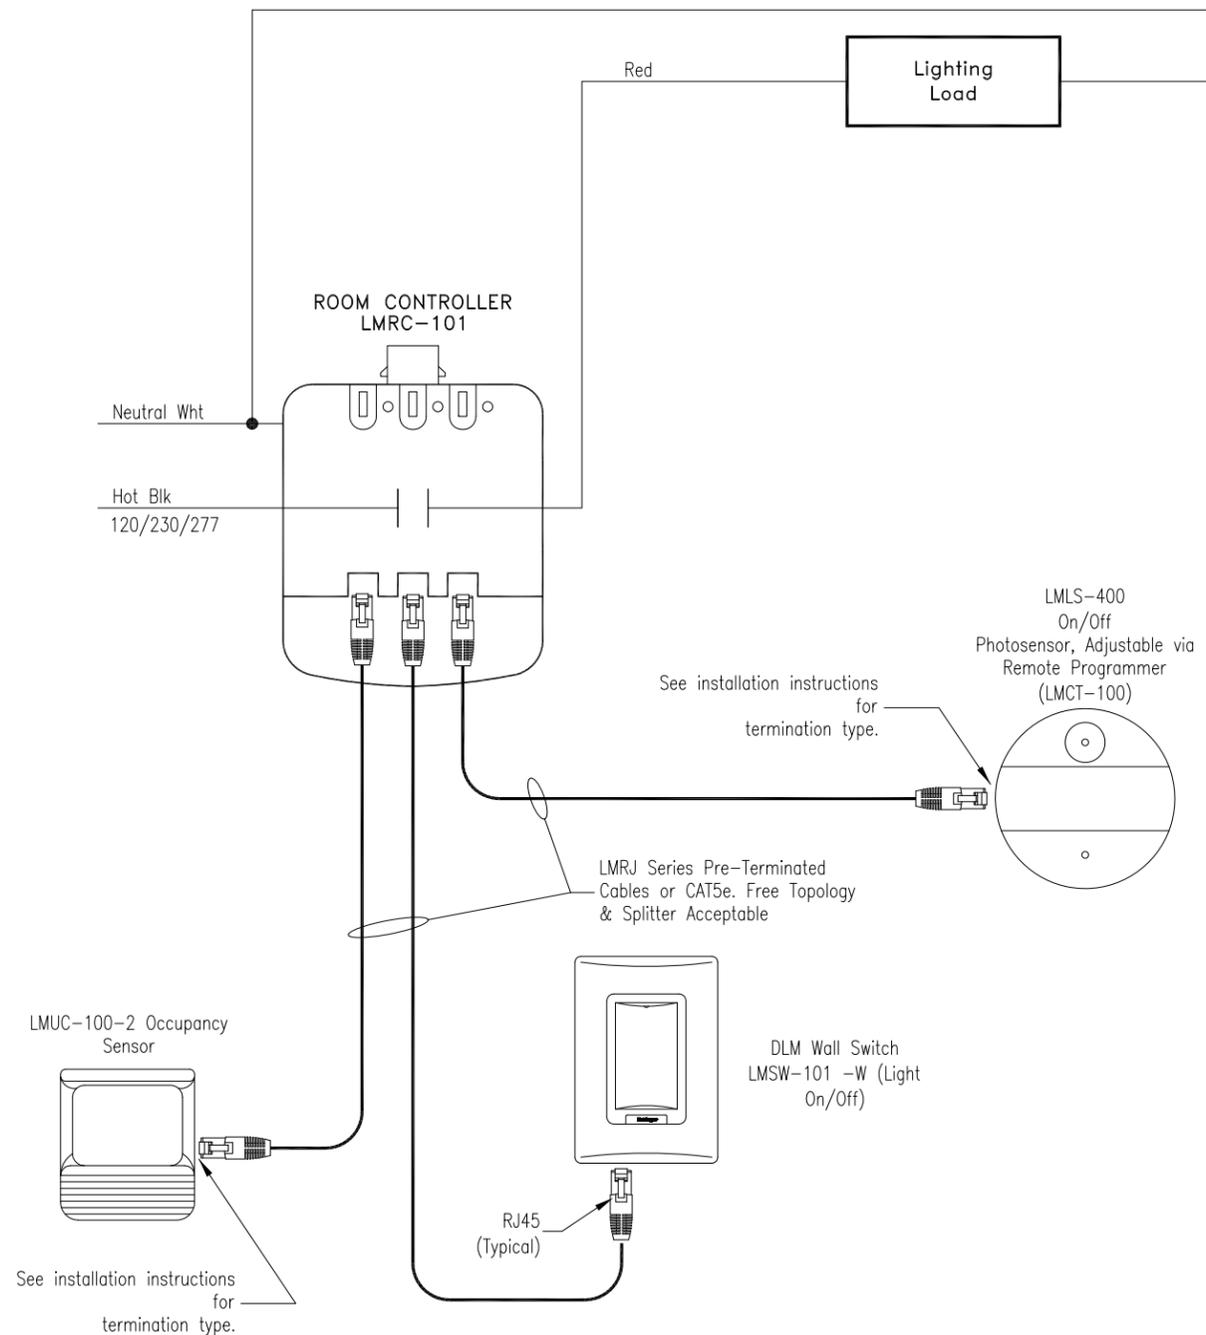


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Room Controller Dimension and Mounting

SCALE: N.T.S.



DEVICES ARE PRESET FOR PLUG n' GO™ OPERATION, with field adjustments.

Sequence of Operation: When ambient light levels exceed the off setpoint, the Photosensor turns Lighting Load (a) off. It will turn connected Lighting Load (a) back on when the on setpoint is triggered. The Occupancy Sensor shall turn on the Lighting Load and will remain on for additional 10 minutes (adjustable). The wall switches shall turn on the each load for the time setting for the occupancy sensor (10 minutes adjustable). The products are based on the Watt Stopper DLM System.

Daylighting On/Off Photosensor with Single-relay Room Controller and Occupancy Sensor - Office Controls

SCALE: N.T.S.

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1	01/20/2011	SCHEMATIC DESIGN
NO	DATE	ISSUED FOR

PROJECT
WESTREC FLOATING WASHROOMS

SHEET TITLE
ELECTRICAL DETAILS

DRAWN: NAP	SHEET NO.
CHECKED: TS	E3-3
APPROVED: TS	
JOB NO. 10.09.10	

ELECTRICAL NOTES

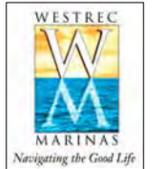
1. ALL WORK SHALL BE DONE AS PER COMMONWEALTH EDISON, AND THE OWNER'S ELECTRICAL REQUIREMENTS
2. THE ELECTRICAL CONTRACTOR SHALL VERIFY EXISTING CONDITIONS AT THE PROJECT SITE BEFORE SUBMITTING BID.
3. THE ELECTRICAL CONTRACTOR SHALL PAY ALL FEES, PROVIDE NECESSARY DOCUMENTS AND LICENSES AND OBTAIN THE REQUIRED PERMITS.
4. THE ELECTRICAL CONTRACTOR SHALL GUARANTEE ALL MATERIALS, DEVICES, EQUIPMENT, WORKMANSHIP AND THE SUCCESSFUL OPERATION OF ALL SYSTEMS AND APPARATUS INSTALLED FOR A PERIOD OF ONE YEAR FROM THE DATE OF FINAL ACCEPTANCE, WITHOUT COST TO THE OWNER.
5. THE ELECTRICAL CONTRACTOR SHALL FURNISH ALL MATERIALS, EQUIPMENT, SCAFFOLDING, RIGGING AND LABOR NECESSARY FOR A COMPLETE AND WORKING ELECTRICAL SYSTEMS THROUGH-OUT AND IN ACCORDANCE WITH ALL GOVERNING CODES, THE DRAWINGS, APPROVED SUBMITTALS, OWNER'S REQUIREMENTS AND AS SPECIFIED.
6. THE ELECTRICAL CONTRACTOR SHALL PROVIDE ALL WARRANTIES AND OPERATING INSTRUCTIONS TO THE ARCHITECT PRIOR TO THE FINAL PAYMENT.
7. THE ELECTRICAL CONTRACTOR SHALL TAKE SUCH PROTECTIVE MEASURES AND PRECAUTIONS AS MAYBE REQUIRED OR NECESSARY TO PREVENT INJURY OR ACCIDENTS TO WORKMEN OR PASSERSBY. PROVIDE GUARD RAILS, FENCES, PLANKING, LIGHTING, ETC.. IN ACCORDANCE WITH THE PARTICULAR CONDITIONS AND O.S.H.A. REQUIREMENTS.
8. REMOVE ALL DEBRIS FROM THE JOB SITE DAILY AND LEAVE ALL WORK AND EQUIPMENT IN A CLEAN WORKING ORDER.
9. THE DRAWINGS DO NOT DETAIL ALL FINAL CONNECTIONS TO EQUIPMENT. THE CONTRACTOR SHALL VERIFY SUCH CONNECTIONS AS PER THE MANUFACTURERS' SHOP DRAWINGS AND OTHER REQUIREMENTS.
10. LAYOUT IS DIAGRAMMATIC AND THE CONTRACTOR SHALL INSTALL EQUIPMENT, WIRING AND ELECTRICAL WORK TO MEET FIELD CONDITIONS, AND SHALL PROVIDE THE SHOP DRAWINGS AS NECESSARY. EXACT LOCATION OF LIGHTING FIXTURES, ELECTRICAL EQUIPMENT AND RECEPTACLES SHALL BE APPROVED BY THE ARCHITECT. VERIFY ALL CONDITIONS, SUCH AS INTERIOR WALL SYSTEMS, ETC. WITH ARCHITECTURAL, STRUCTURAL AND MECHANICAL DRAWINGS AND/OR CONSULT WITH THE ARCHITECT/ENGINEER PRIOR TO ROUGHING-IN FOR ELECTRICAL WORK SUCH AS LIGHTING FIXTURES, OUTLETS, SWITCHES, THERMOSTATS AND OTHER DEVICES TO AVOID FIELD CONFLICTS.
11. COORDINATE ALL WORK WITH THE OTHER TRADES. MAINTAIN PROPER CLEARANCES AND HEADROOM AT THE EQUIPMENT AND DEVICES FOR INSPECTION AND SERVICE. ALL LIGHTING FIXTURES ARE TO BE LOCATED AS REQUIRED ON THE JOB TO CLEAR DUCTS, PIPING EQUIPMENT AND/OR MECHANICAL EQUIPMENT.
12. MAINTAIN AS-BUILT SET OF CONTRACT DRAWINGS ON ALL WORK AS INSTALLED, SHOWING SIZE AND LOCATION CHANGES.
13. ALL CONDUIT SHALL BE CONCEALED WHERE POSSIBLE. WHEN EXPOSED CONDUIT RUNS ARE NECESSARY, THEY SHALL BE PIPED IN STRAIGHT LINES, PARALLEL AND/OR PARTICULAR TO THE BUILDING CONSTRUCTION.
14. THE ELECTRICAL CONTRACTOR SHALL INCLUDE ALL MISCELLANEOUS ITEMS REQUIRED TO COMPLETE THE WORK, INCLUDING MOVING AND RIGGING MATERIAL AND EQUIPMENT, ALL HANGERS, SUPPORTS, ANCHORS, EXPANSION MEANS, CONDUIT, WIRE, OUTLET BOXES, FITTINGS AND SLEEVES.
15. ALL TELEPHONE, SECURITY, TV AND DATA RACEWAY SHALL BE DONE BY THE ELECTRICAL CONTRACTOR WITH CONDUIT, OUTLETS, BOXES AND TERMINAL CABINETS. TELEPHONE, SECURITY, TV AND DATA WIRING SHALL BE BY THE OWNER.
16. MECHANICAL CONTRACTORS SHALL FURNISH MOTORS, MOTOR STARTERS, AND CONTROLS FOR MECHANICAL EQUIPMENT PROVIDED FOR THE PROJECT AND SHALL SET ALL LOOSE MOTORS FOR THE MECHANICAL EQUIPMENT. THE ELECTRICAL CONTRACTOR SHALL MOUNT ALL STARTERS, FURNISH AND INSTALL ALL DISCONNECT SWITCHES AND PROVIDE ALL POWER WIRING FOR THE MECHANICAL EQUIPMENT. THE MECHANICAL CONTRACTORS SHALL FURNISH MANUAL MOTOR STARTERS FOR SINGLE PHASE MOTORS.
17. ALL MATERIALS, PRODUCTS AND EQUIPMENT, INCLUDING ALL COMPONENTS THEREOF, SHALL BE NEW AND SUCH AS APPEAR ON THE UNDERWRITERS LABORATORIES LIST OF APPROVED ITEMS, AND SHALL MEET REQUIREMENTS OF ASTM, IEEE, IPCEA, NEC, NEMA, RLM, CBM AND OTHER RECOGNIZED STANDARDS AND SHALL BE SIZED IN CONFORMITY WITH REQUIREMENTS OF THE NATIONAL ELECTRICAL CODE AND OTHER APPLICABLE CODES, WHICHEVER ARE MORE STRINGENT.
18. ALL WIRING DEVICES(SWITCHES, RECEPTACLES, ETC.) SHALL BE STANDARD GRADE
19. ALL GROUNDING, SURGE PROTECTION AND LIGHTNING PROTECTION SHALL BE AS PER COMMONWEALTH EDISON, AND CODE OFFICIALS' REQUIREMENTS.
20. TEMPERATURE CONTROL WIRING SHALL BE FURNISHED BY THE MECHANICAL CONTRACTORS, UNLESS NOTED OTHERWISE. THE ELECTRICAL CONTRACTOR SHALL PROVIDE 120 VOLT POWER SOURCE(S) WHERE REQUIRED FOR THE TEMPERATURE CONTROLS.
21. PROVIDE TYPEWRITTEN CIRCUIT DIRECTORY AND INSTALL IN STEEL FRAME SECURED TO THE INTERIOR OF PANEL DOOR. LABEL THE CIRCUIT BREAKERS WITH TYPEWRITTEN LABELS. LABEL ELECTRICAL PANELS, CONTROL BOXES, AND OTHER ELECTRICAL DEVICES WITH ENGRAVED LABELS.
22. PROVIDE WIRING TO ALL PLUMBING EQUIPMENT
23. THE ENGINEER SHALL NOT HAVE CONTROL OVER OR CHARGE OF AND SHALL NOT BE RESPONSIBLE FOR CONSTRUCTION MEANS, METHODS, TECHNIQUES, SEQUENCES OR PROCEDURES, OR FOR SAFETY PRECAUTIONS AND PROGRAMS IN CONNECTION WITH THE WORK, SINCE THESE ARE SOLELY THE CONTRACTOR'S RESPONSIBILITY UNDER THE CONTRACT FOR CONSTRUCTION.
24. THE ENGINEER IS NOT EMPOWERED TO AUTHORIZE OR ISSUE ANY FIELD ORDERS OR TO VERBALLY GIVE DIRECTIONS TO ANY CONTRACTOR WHICH SHALL AFFECT TIME OF COMPLETION OR THE BASE AMOUNT OF THE CONTRACT BETWEEN THE OWNER AND THE CONTRACTOR, OR ANY OTHER MATTERS RELATING TO THE CONSTRUCTION OF THE SYSTEMS IN GENERAL. ENGINEER SHALL ONLY CLARIFY THE INTENT OF THE DOCUMENTS.
25. EQUIPMENT SHALL BE IDENTIFIED WITH PERMANENT NAMEPLATES AS TO NAME AND/OR FUNCTION (DISTRIBUTION PANELS, LIGHTING PANELS.
26. ALL ELECTRIC WORK SHALL BE INSTALLED SO AS TO BE READILY ACCESSIBLE FOR SERVICING. HANGERS SHALL INCLUDE ALL MISCELLANEOUS STEEL, SUCH AS CHANNELS, RODS, ETC., NECESSARY FOR THE INSTALLATION OF WORK AND SHALL BE FASTENED TO STEEL, CONCRETE OR MASONRY, BUT NOT TO PIPING. ALL CONDUIT SHALL BE CONCEALED WHERE POSSIBLE. EXPOSED CONDUITS SHALL BE IN STRAIGHT LINES PARALLEL WITH OR AT RIGHT ANGLES TO COLUMN LINES OR BEAMS
27. MINIMUM SIZES OF CONDUITS ARE SHOWN AND SHALL 3/4 INCH FOR ALL OTHER APPLICATIONS. FITTINGS SHALL BE OF THE COMPRESSION TYPE. PROVIDE GREEN GROUND WIRE IN FEEDERS. EMT MAY BE USED FOR FEEDERS AND BRANCH CIRCUITS RUN ABOVE SUSPENDED CEILINGS OR CONCEALED IN INTERIOR PARTITIONS 3/4 INCH MINIMUM SIZE. ABOVE 1 INCH SIZE SHALL NOT BE CONCEALED IN Poured CONCRETE SLAB OR WALLS. IMC OR HEAVY WALL CONDUIT SHALL HAVE THREADED CONNECTIONS. CONDUIT SYSTEMS INSTALLED IN PLENUM CEILINGS SHALL CONFORM TO REQUIREMENTS FOR PLENUM CEILING INSTALLATIONS.
28. OUTLETS BOXES SHALL BE STEEL, GALVANIZED. SIZES 4 AND 4-11/16 INCH, WITH FIXTURE STUDS, AS REQUIRED. FLUSH DEVICE BOXES WITH METAL COVER PLATES SHALL BE FINISHED TO MATCH ADJACENT HARDWARE FOR CONCEALED USE.
29. SWITCHES FOR LIGHTING CIRCUIT SHALL BE 120 VOLT, 20 AMPERE.
30. RECEPTACLES SHALL BE OF THE NEMA GROUNDING TYPE DUPLEX RECEPTACLES. WATERPROOF RECEPTACLE SHALL HAVE STAINLESS STEEL DEVICE PLATE, WITH PVC GASKET COVER PLATE.
31. DISCONNECT SWITCHES SHALL BE FUSED OR NON-FUSED HEAVY DUTY, NEMA TYPE AS REQUIRED BY CODE, IN ENCLOSURE SUITABLE FOR THE APPLICATION.
32. LIGHTING FIXTURES SHALL BE AS FOLLOWS: FLUORESCENT FIXTURE SHALL BE FOR RAPID START LAMPS SHALL BE U.L. LISTED AND NEC APPROVED. WITH HIGH POWER FACTOR ELECTRONIC BALLAST.

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NO	DATE	ISSUED FOR

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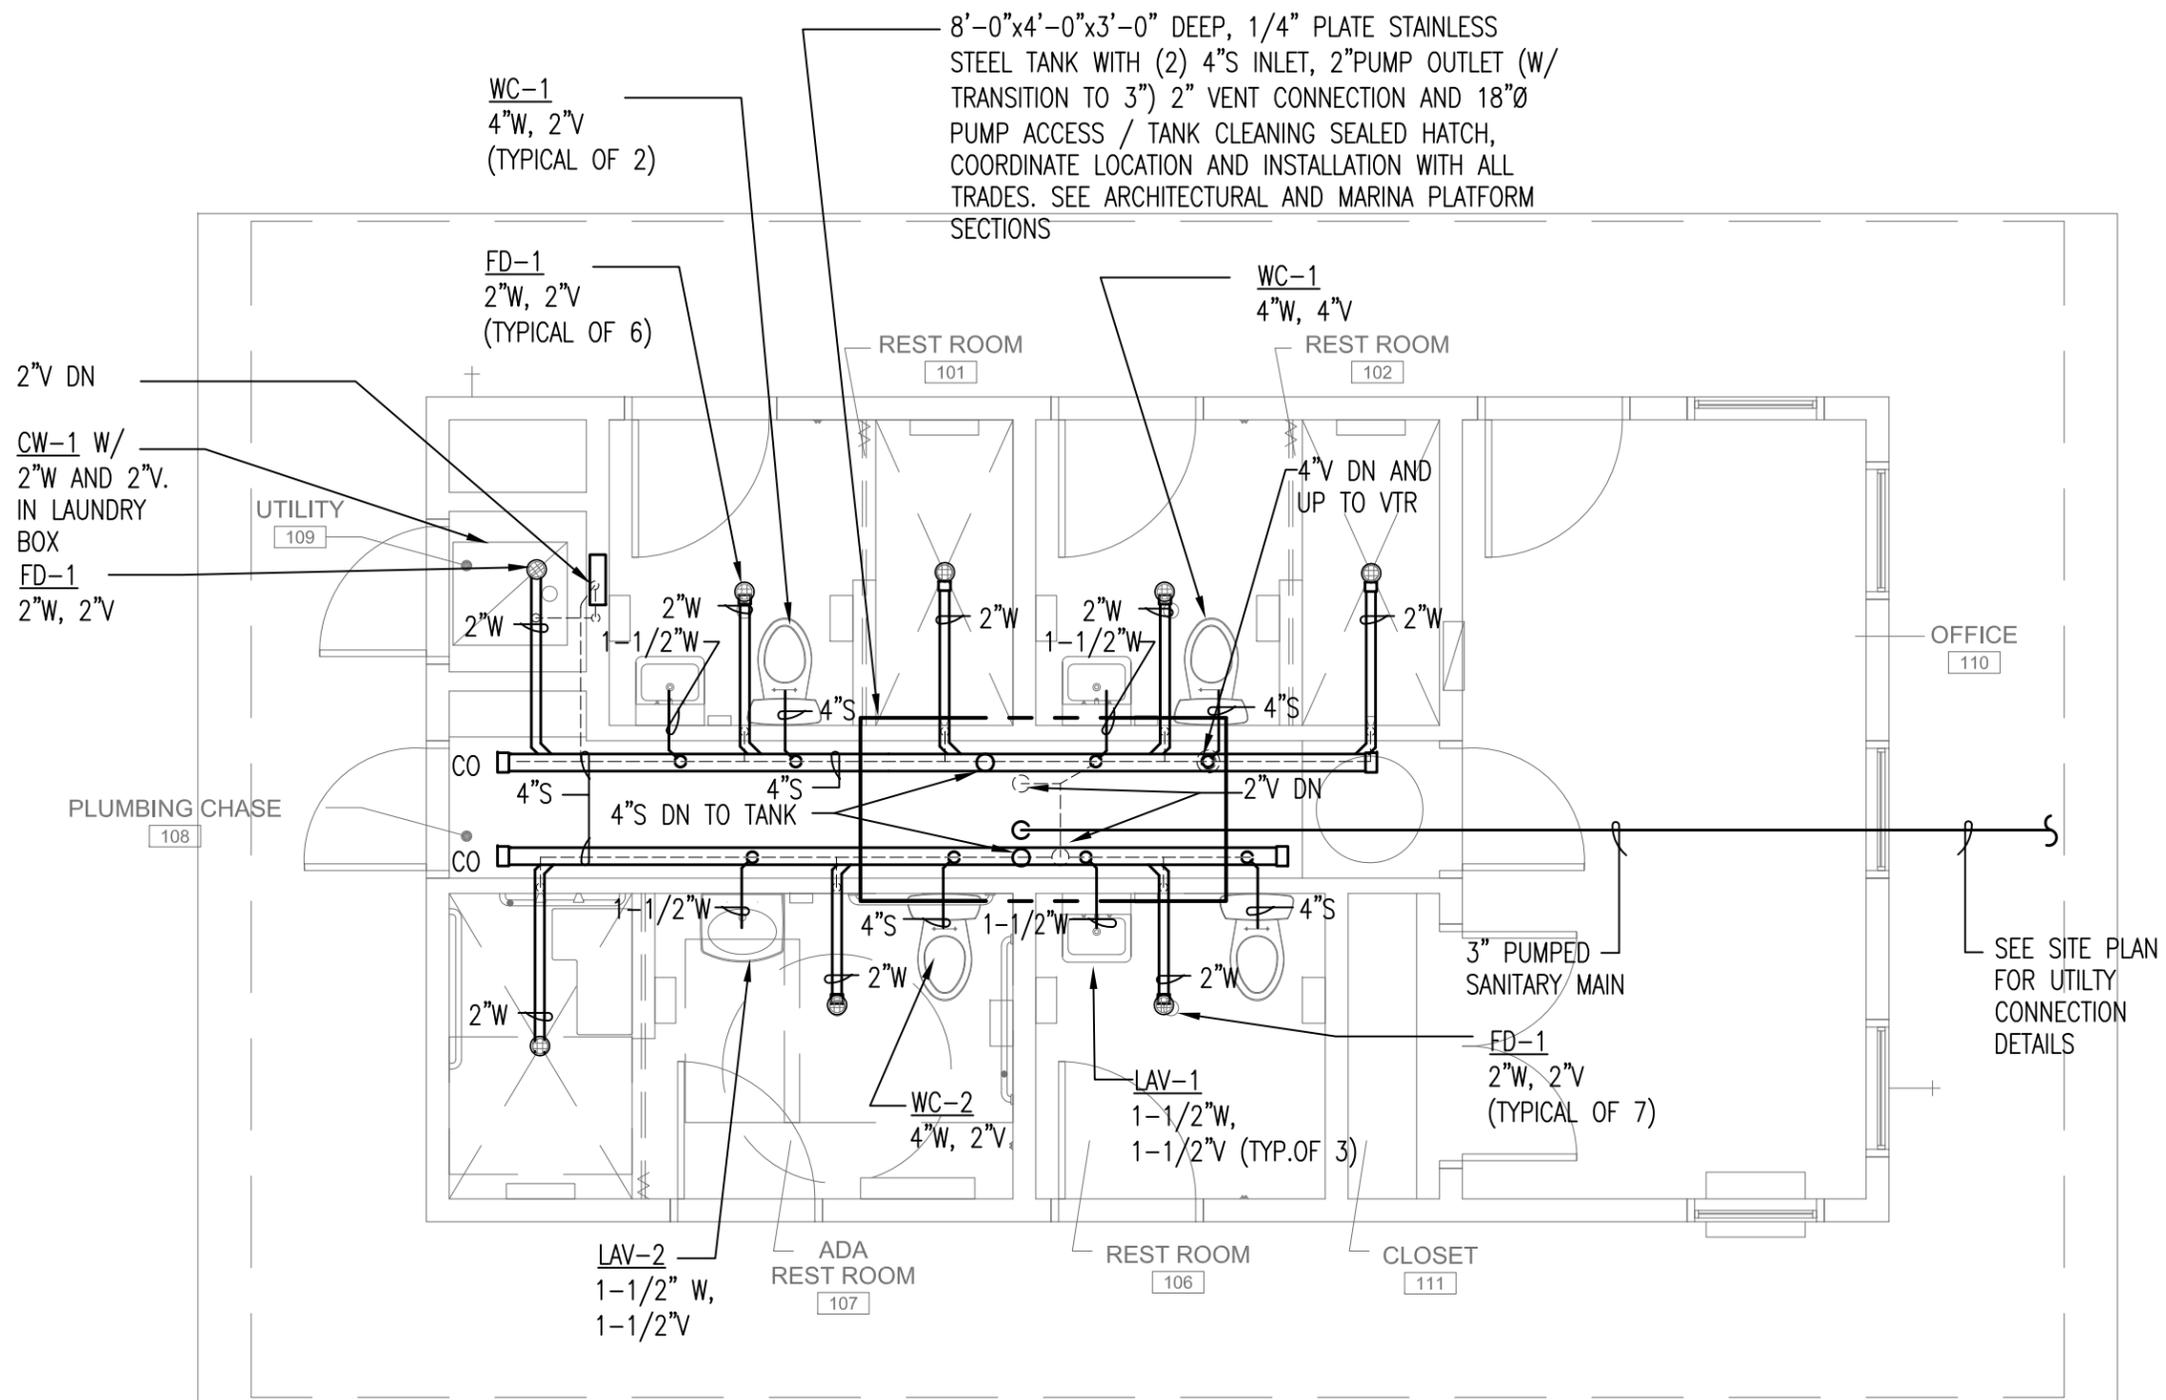
SHEET TITLE
ELECTRICAL NOTES

DRAWN: NAP	SHEET NO. E3-4
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1 PLUMBING PLAN - SANITARY
SCALE: 1/4" = 1'-0"

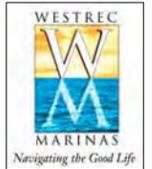
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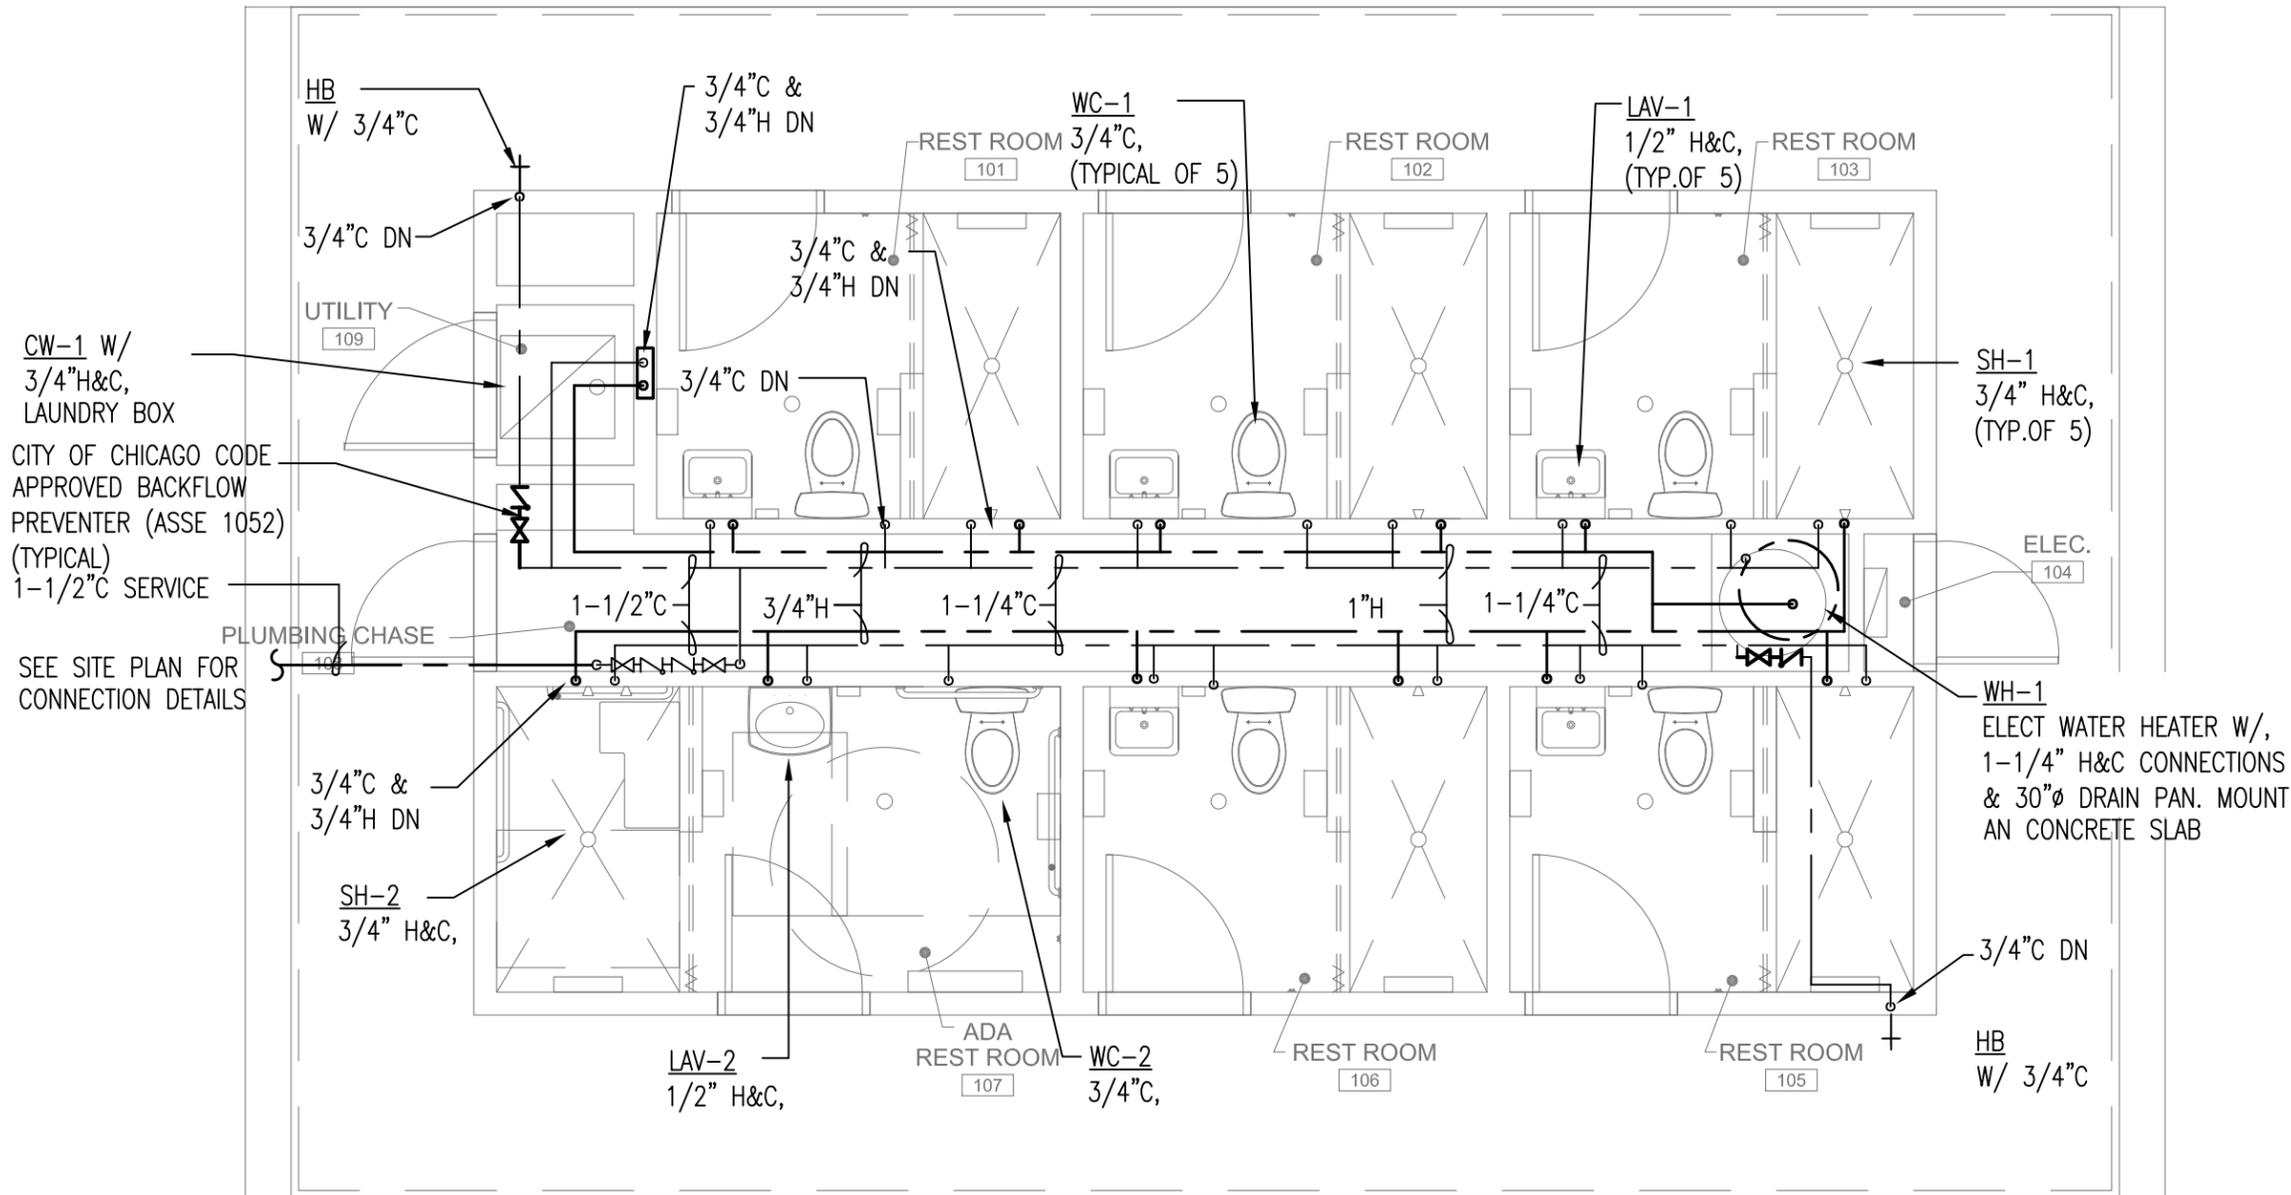
SHEET TITLE
PLUMBING FLOOR PLAN - SANITARY (JACKSON)

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1 PLUMBING PLAN - WATER
SCALE: 1/4" = 1'-0"

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NO	DATE	ISSUED FOR

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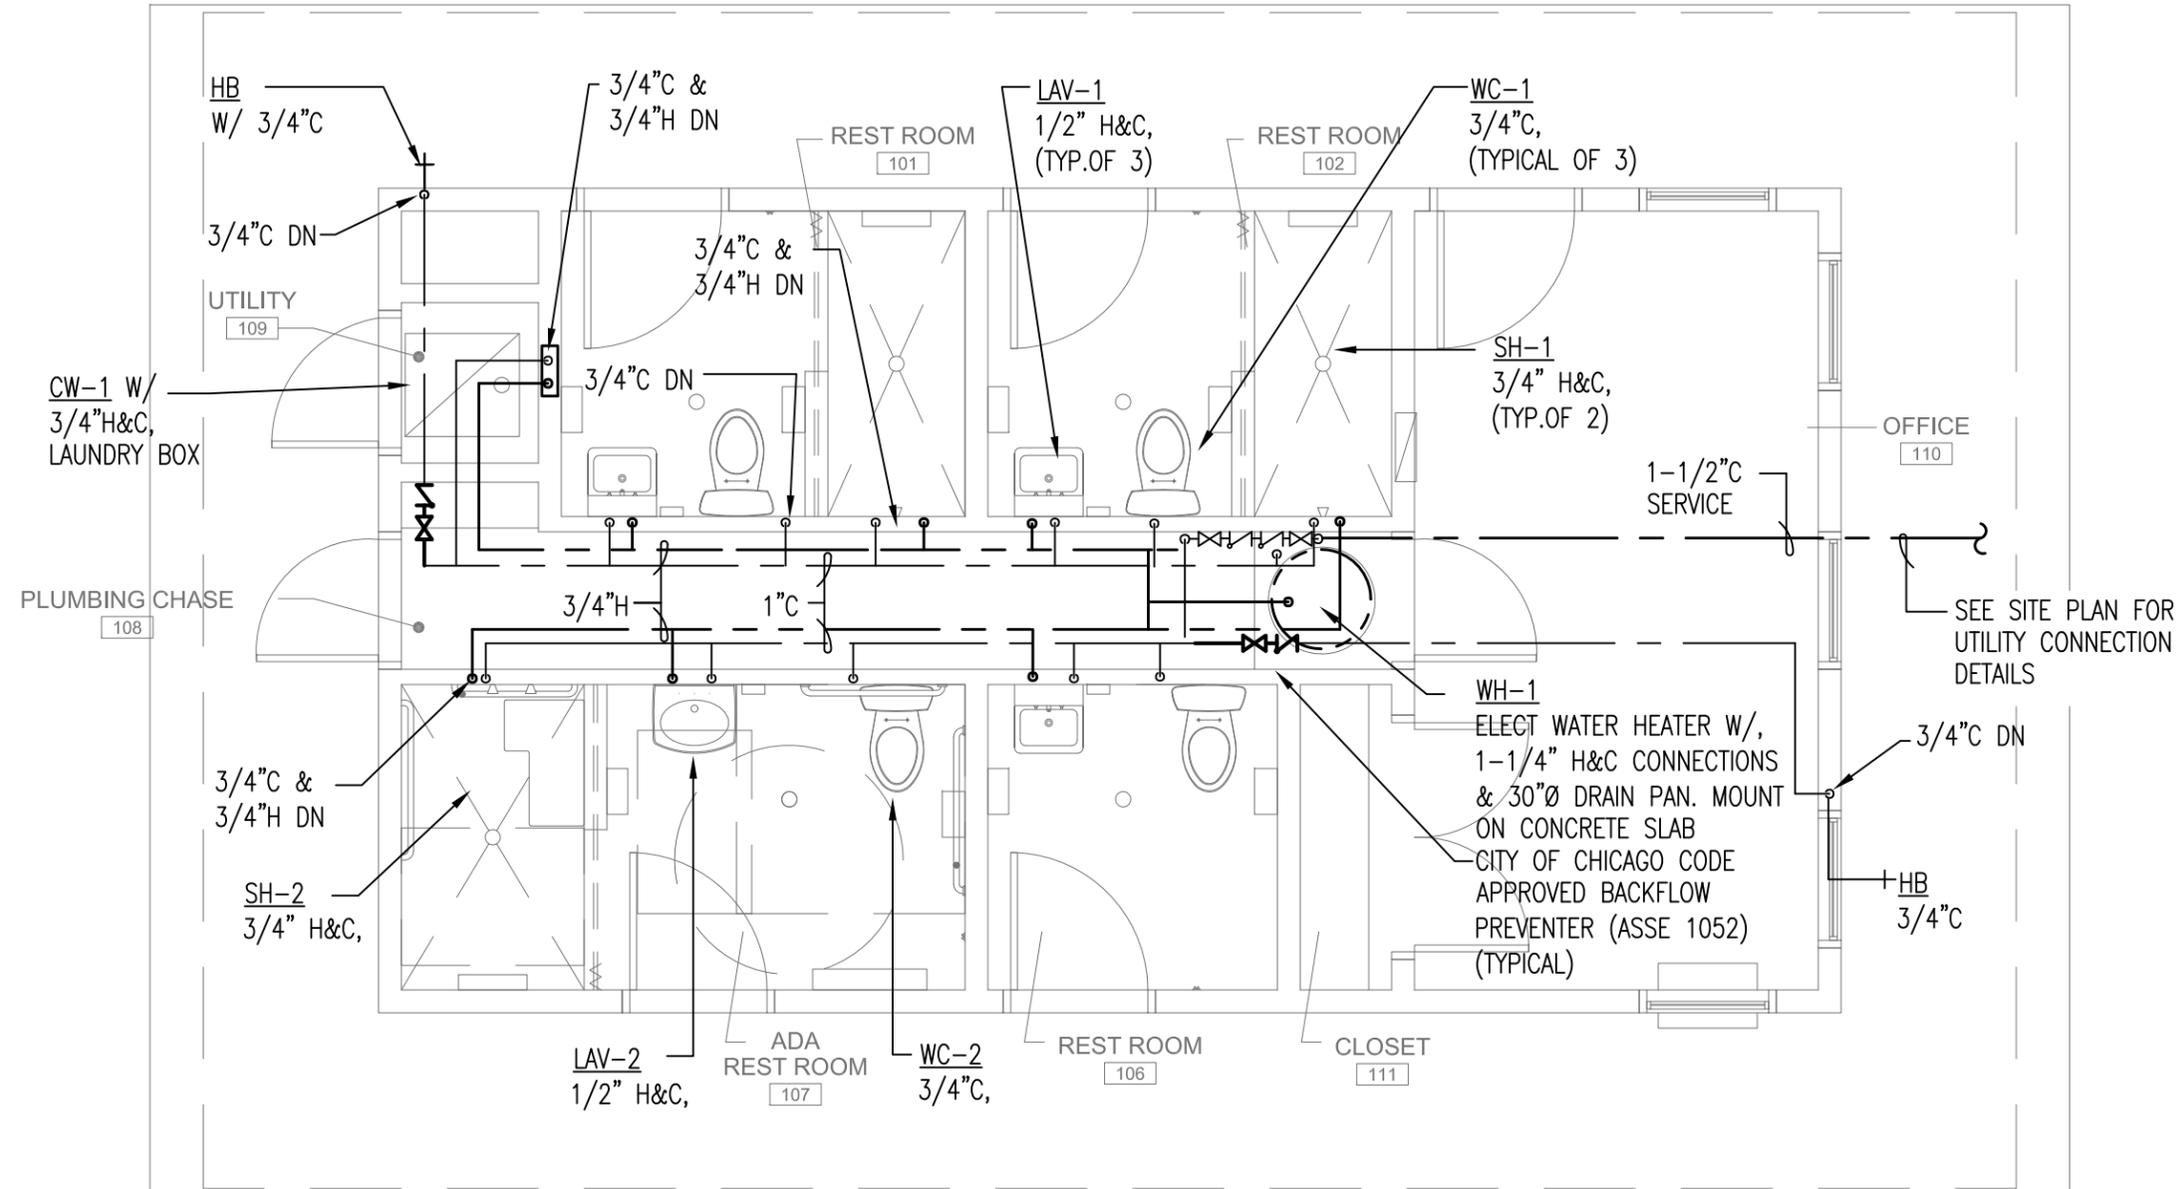
SHEET TITLE
PLUMBING FLOOR PLAN - WATER

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1 PLUMBING PLAN - WATER
SCALE: 1/4" = 1'-0"

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WESTREC FLOATING WASHROOMS

SHEET TITLE
PLUMBING FLOOR PLAN - WATER (JACKSON)

DRAWN: NAP	SHEET NO.
CHECKED: TS	P1-2J
APPROVED: TS	
JOB NO. 10.09.10	

PLUMBING FIXTURE SCHEDULE

MANUFACTURERS:								
VITREOUS CHINA AND ENAMELED STEEL FIXTURES:				AMERICAN-STANDARD, KOHLER, ELJER				
SINGLE HANDLE FAUCETS:				CHICAGO, SLOAN, SYMMONS				
NON-FREEZE SILL COCKS:				WOODFORD, JR SMITH				
WATER HEATERS:				RHEEM, STATE, A.O. SMITH, RUUD, PVI				
SUMP AND SEWAGE EJECTORS:				HYDROMATIC, WEIL, ZOELLER				
SHOWER AND BATHTUB VALVES AND OUTLETS:				POWERS, SYMMONS, CHICAGO				
FLOOR DRAINS, CARRIERS:				JR SMITH, JOSAM, WADE, ZURN				

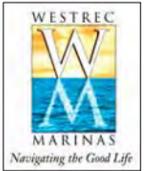
TOTAL NUMBER OF FIXTURES	FIXTURE TAG	MODEL NUMBER	FAUCET AND FITTINGS	ADA REQUIRED	MATERIALS	DIMENSIONS	MOUNTING	DESCRIPTION
5	WC-1	AMER STD GLENWALL PRESSURE-ASSISTED WALL MOUNTED 2093.100	SLOAN FLUSHMATE TANK SYSTEM	SEE ARCHITECT DWGS FOR MOUNTING HEIGHTS	VITREOUS CHINA	30" HIGH AFF X 29.5" DEEP X 19.5" WIDE	SEE ARCHITECT DWGS FOR MOUNTING HEIGHTS	1.6 GALLONS PER FLUSH, MINIMUM 20 PSI WATER SUPPLY, EXTRA HEAVY DUTY OPEN FRONT SEAT W/O COVER, BEMIS/ CHURCH/ AM STD SEAT.
1	WC-2	AMER STD GLENWALL PRESSURE-ASSISTED WALL MOUNTED 2093.100	SLOAN FLUSHMATE TANK SYSTEM	SEE ARCHITECT DWGS FOR MOUNTING HEIGHTS	VITREOUS CHINA	30" HIGH AFF X 29.5" DEEP X 19.5" WIDE	SEE ARCHITECT DWGS FOR MOUNTING HEIGHTS	1.6 GALLONS PER FLUSH, MINIMUM 20 PSI WATER SUPPLY, EXTRA HEAVY DUTY OPEN FRONT SEAT W/O COVER, BEMIS/ CHURCH/ AM STD SEAT.
5	LAV-1	AMER STAND LUCERNE 0355.012 OR 0356.421	CHICAGO FAUCET 116.201.21.1 HYTRONIC BATTERY POWERED SENSOR	SEE ARCHITECT DWGS FOR MOUNTING HEIGHTS	VITREOUS CHINA	20.5 X 18.25, 4 INCH CENTERS OR SINGLE HOLE	SEE ARCHITECT DWGS FOR MOUNTING HEIGHTS	CAST GRID DRAIN WITH 1 1/4" TAILPIECE, 1 1/4 X 1 1/4 SEMI CAST, 17 GAUGE, "P" TRAP WITH CLEAN OUT.
1	LAV-2	AMER STAND LUCERNE 0355.012 OR 0356.421 ADA MOUNTING AND CLEARANCE	CHICAGO FAUCET 116.201.21.1 HYTRONIC BATTERY POWERED SENSOR	SEE ARCHITECT DWGS FOR MOUNTING HEIGHTS	VITREOUS CHINA	20.5 X 18.25, 4 INCH CENTERS OR SINGLE HOLE	WALL MOUNTED WITH CONCEALED CHAIR CARRIER	ADA CLEARANCES, INSULATED STOP AND TRAP COVERS, CAST GRID DRAIN WITH 1 1/4" TAILPIECE, 1 1/4 X 1 1/4 SEMI CAST, 17 GAUGE, "P" TRAP WITH CLEAN OUT.
5	SH-1	BASIN AND SURROUND BY GENERAL CONTRACTOR	POWERS E420 SERIES OR CHICAGO FAUCET 1907-600CP, THERMOSTATIC, PRESSURE BALANCING	NOT APPLICABLE	MAXIMUM 110F, CHECK-STOPS, SURFACE MOUNTED CHROMED BRASS, SHOWER HEAD			THERMOSTATIC/PRESSURE BALANCING SHOWER VALVE, ADJUSTABLE PATTERN SHOWER HEAD, ARM AND WALL FLANGE 1/2" NOMINAL COPPER HOT AND COLD SUPPLY INLETS AND OUTLETS, SHOWER VALVE CYCLES FROM COLD TO HOT, THERMOSTATIC/PRESSURE BALANCING CARTRIDGE INTEGRAL SERVICE STOPS, ADJUSTABLE TEMPERATURE LIMIT STOP
1	SH-2	BASIN AND SURROUND BY GENERAL CONTRACTOR	POWERS E420 SERIES OR CHICAGO FAUCET 1907-600CP, THERMOSTATIC, PRESSURE BALANCING	SEE ARCHITECT DWGS FOR MOUNTING HEIGHTS	WHEELCHAIR ACCESSIBLE SHOWER WITH DRAIN AND ADA FITTINGS AND RAMP, MAXIMUM 110F, CHECK-STOPS, SURFACE MOUNTED CHROMED BRASS, SHOWER HEAD WITH BY-PASS DIVERTER, REMOVABLE HAND HELD HEAD & HOSE, WALL HOOKS, INLINE VACUUM BREAKER.			THERMOSTATIC/PRESSURE BALANCING SHOWER VALVE, ADJUSTABLE PATTERN SHOWER HEAD, ARM AND WALL FLANGE 1/2" NOMINAL COPPER HOT AND COLD SUPPLY INLETS AND OUTLETS, SHOWER VALVE CYCLES FROM COLD TO HOT, THERMOSTATIC/PRESSURE BALANCING CARTRIDGE INTEGRAL SERVICE STOPS, ADJUSTABLE TEMPERATURE LIMIT STOP
	SE-1	MYERS MODEL WHR 10 H	2 INCH DISCHARGE WITH CHECK AND GATE VALVES, UNION	NOT APPLICABLE	CAST-IRON CASING, HOUSING AND IMPELLERS, STAINLESS STEEL SHAFT,	2 HP, 3450 RPM, 208/240 VOLT, 1 PHASE, 70 GPM AT 55 FOOT HEAD	MOUNT IN 24" DIAMETER BASIN W/ SEALED COVER, VENT AND DISCHARGE CONNECTIONS.	2 INCH SUBMERSIBLE SEWAGE EJECTOR PUMP, STAINLESS STEEL SHAFT, PERFORATED STEEL PLATE STRAINER (ELEVATED ABOVE BOTTOM OF BASIN). PROVIDE WITH HIGH WATER ALARM, CODE APPROVED SANITARY DISCHARGE LOCATION REQUIRED.

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SHEET TITLE
PLUMBING SCHEDULES

DRAWN: NAP	SHEET NO. P2-1
CHECKED: TS	
APPROVED: TS	
JOB NO. 10.09.10	

PLUMBING FIXTURE SCHEDULE

MANUFACTURERS:								
VITREOUS CHINA AND ENAMELED STEEL FIXTURES:				AMERICAN-STANDARD, KOHLER, ELJER				
SINGLE HANDLE FAUCETS:				CHICAGO, SLOAN, SYMMONS				
NON-FREEZE SILL COCKS:				WOODFORD, JR SMITH				
WATER HEATERS:				RHEEM, STATE, A.O. SMITH, RUUD, PVI				
SUMP AND SEWAGE EJECTORS:				HYDROMATIC, WEIL, ZOELLER				
SHOWER AND BATHTUB VALVES AND OUTLETS:				POWERS, SYMMONS, CHICAGO				
FLOOR DRAINS, CARRIERS:				JR SMITH, JOSAM, WADE, ZURN				

TOTAL NUMBER OF FIXTURES	FIXTURE TAG	MODEL NUMBER	FAUCET AND FITTINGS	ADA REQUIRED	MATERIALS	DIMENSIONS	MOUNTING	DESCRIPTION
	SANITARY BASIN	FABRICATED FOR PROJECT	TWO 4" SANITARY INLETS, ONE 2" VENT OUTLET, 2" PUMPED OUTLET, SEALED POWER CORD OPENING,	NOT APPLICABLE	0.25 INCH THICK STAINLESS STEEL PLATE	MINIMUM 96 CU FT VOLUME: 48' WIDE X 96" LONG X 36" DEEP	MOUNT ON UNDERSIDE OF FLOATING BARGE STRUCTURE,	MOUNT IN PLUMBING SHAFT WITH FULL ACCESS TO PLUMBING CONNECTIONS. PROVIDE MINIMUM 18" DIA METER PUMP REPAIR /REPLACEMENT AND TANK CLEANING SEALED ACCESS PANEL.
	FD-1	JR SMITH MODEL 2010	NOT APPLICABLE	NOT APPLICABLE	CAST IRON WITH NICKEL BRASS FINISHES	2, 3 4 INCH OUTLETS AS REQUIRED	RECESSED, FLOOR MOUNTED	5 INCH DIAMETER NICKEL BRASS STRAINER HEAD, PROVIDE WITH FUNNEL AS REQUIRED FOR CONDENSATE OR OTHER INDIRECT DRAIN REQUIREMENTS.
	HB	WOODFORD B75 OR RB-75						RECESSED SILL COCK, WITH FLUSH LOCKING COVER, ANTI SIPHON VACUUM BREAKER, CHROME FINISHED EXTERIOR AND FLUSH COVER. PROVIDE WITH ASSE-1052, TESTABLE, CODE-APPROVED WALL MOUNTED BACKFLOW PREVENTER.
1	LB/CW	LAUNDRY BOX GUY GRAY MODEL	NOT APPLICABLE	NOT APPLICABLE				LAUNDRY BOX WITH 20 AMP GFCI RECEPTACLE, 2 INCH DRAIN PIPE CONNECTION AND (2) 3/4" HOSE BIBB (HOT AND COLD) CONNECTIONS WITH 1/2" SWEATED BRASS CONNECTIONS.
19	TOTAL							

GENERAL PLUMBING FIXTURE NOTES

1	ALL PUBLIC PLUMBING FIXTURE INSTALLATIONS SHALL BE VANDALPROOF AND ADA ACCESSIBLE.
2	FIXTURE AND EQUIPMENT LOCATIONS, COLORS, AND MOUNTING SHALL BE APPROVED BY THE ARCHITECT AND OWNER.
3	PROVIDE CHICAGO OR MCGUIRE BRASS/CHROME, HEAVY-DUTY ANGLE STOPS ON ALL FIXTURES, VANDALPROOF HANDLE AS NECESSARY. 1/4 TURN, LOOSE-KEY IN PUBLIC AREAS IS ACCEPTABLE.
4	ALL SINKS AND OTHER FIXTURES SHALL HAVE 17 GAUGE CAST BRASS/CHROME TUBING AND TRAPS WITH CLEAN OUTS
5	ALL HANDICAP ACCESSIBLE FIXTURES SHALL HAVE TRAPS AND SUPPLY PIPING WITH INSULATION, TIGHT TO WALL
6	HANDICAP, ACCESSIBLE PLUMBING FIXTURE MATERIALS AND INSTALLATIONS SHALL MEET STATE OF ILLINOIS, ADA AND ANSI REQUIREMENTS. INSULATE TRAP, SUPPLIES AND MIXING VALVES WITH MCGUIRE, PRO-WRAP, OR TRUEBRO PREFABRICATED PIPE WRAP.
7	ACCESSIBLE MOUNTING HEIGHTS AND CLEARANCES AS ADA AND ANSI
8	PROVIDE VANDALPROOF ANSI 1016/1017 115F MAXIMUM MIXING VALVE FOR EACH FAUCET.
9	THERE ARE USES FOR THE ACCESSIBLE SHOWERS AND PROPER FITTINGS MUST BE PROVIDED TO FACILITATE THE INTENT: 1) FIXED SHOWER HEAD WITH ADJUSTABLE OUTLET, 2) HANDHELD SHOWER HEAD WITH SLIDING SHOWER HEAD HOOK, DIVERTOR BETWEEN FIXED HEAD AND HAND-HELD HEAD. ALL THREE FEATURES MUST BE INSTALLED.

PLUMBING MATERIALS AND ACCESSORIES:

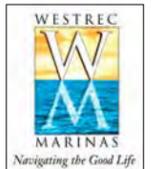
1	SUSPENDED WASTE AND VENT PIPING, PIPE 2-1/2" AND LARGER SERVICE WEIGHT HUB AND SPIGOT CAST IRON PIPE. 2" AND SMALLER TYPE K COPPER.
2	INTERIOR HOT AND COLD WATER DISTRIBUTION PIPING, 3" AND SMALLER - TYPE L HARD DRAWN COPPER TUBING.
3	ALL UNDERGROUND SANITARY SEWER LINES SHALL BE STANDARD SERVICE WEIGHT, CAST-IRON OF SIZES INDICATED ON THE DRAWING. MINIMUM SIZE IS 4 INCH DIAMETER.
4	IN ALL CASES WHERE COPPER PIPE CONNECTIONS ARE MADE TO DISSIMILAR METAL, PROVIDE DIELECTRIC FITTINGS.
5	BALL VALVES FOR SHUT-OFF SHALL BE AS MANUFACTURED BY MILWAUKEE OR NIBCO.
6	FLOOR DRAINS FOR GENERAL AREA OR TOILET ROOMS, ROUND POLISHED BRONZE TOP.
7	PROVIDE PROPER AIR CHAMBERS AS PER CITY AND STATE PLUMBING CODE. 12 INCH AT EACH FIXTURE SUPPLY AND 24 INCH HIGH AT TOP

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1	01/20/2011	SCHEMATIC DESIGN
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PROJECT
WESTREC FLOATING WASHROOMS

SHEET TITLE
PLUMBING SCHEDULES

DRAWN: NAP	SHEET NO.
CHECKED: TS	P2-2
APPROVED: TS	
JOB NO. 10.09.10	

WATER HEATER SCHEDULE

STATE, AO SMITH, RHEEM, BRADFORD-WHITE, LOCHINVAR EQUAL MODELS APPROVED. EXCEED ASHRAE ENERGY STDS, 120 VOLT POWER TO IGNITION AND/OR VENT SYSTEM, P & T RELIEF VALVE RUN TO PLUMBING DRAIN, PROVIDE CODE-APPROVED EXPANSION TANK (2 OR 5 GALLON IF REQUIRED), DI-ELECTRIC UNIONS; ASME, NSF, UL, AGA APPROVAL AS REQUIRED.

THE WATER HEATER DESIGN AND INSTALLATION SHALL MEET TO REQUIREMENTS ON THE INTERNATIONAL ENERGY CONSERVATION CODE AND CHICAGO ENERGY CONSERVATION CODE (CBC 13 (18-13-804.1)).

PROVIDE 18 GAUGE DRAIN PAN AND AUXILIARY WASTE LINE TO CODE-APPROVED OPEN SITE SANITARY DRAIN. MOUNT ON STRUCTURE (MINIMUM 1-1/2 INCH ANGLE STEEL) HIGH ABOVE FLOOR.

ELECTRIC WATER HEATER FEATURES: SURFACE MOUNTED THERMOSTAT STEP CONTROL (MODULATION) OR IMMERSION THERMOSTATS, 3" (76MM) NON-CFC FOAM INSULATION FACTORY INSTALLED HYDROJET® SEDIMENT REDUCTION SYSTEM VITRAGLAS® LINING—ENGINEERED ENAMEL PROTECTION FROM THE HIGHLY CORROSIVE EFFECTS OF HOT WATER. WATER CONNECTIONS—1/2" NPT FACTORY INSTALLED TRUE DIELECTRIC FITTINGS EXTEND WATER HEATER LIFE AND EASES INSTALLATION. ELEMENTS—SCREW IN STYLE. N TWO MAGNESIUM ANODE RODS, HAND HOLE CLEANOUT, ASME CONSTRUCTION COMPLETELY PRE-WIRED—WITH PRESSURE LUG TERMINAL BLOCK

HEATER TAG	MODEL NO.	ENERGY INPUT (KW)	INSULATION	STORAGE VOLUME (GALS)	RECOVERY CAPACITY AT 90F RISE (GALS/HR)	DIMENSIONS ("DIAMETER X" HEIGHT)	CLEARANCE
WH-1	BRADFORD WHITE M-H-80(A)-18 KW-3SF	18	2 INCH FOAM	80	83	26" DIAMETER X 62" HIGH	36" IN FROM FRONT
		KW					

PLUMBING FIXTURE UNIT SCHEDULE

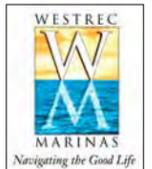
PLUMBING FIXTURE TAG	PLUMBING FIXTURE TYPE	TOTAL NUMBER	WATER FIXTURE UNITS PER FIXTURE	TOTAL WATER UNITS	SANITARY FIXTURE UNITS PER FIXTURE	TOTAL SANITARY UNITS	COMMENTS
WC	WATER CLOSET-- FLUSH-TANK PUBLIC	6	5	30	4	24	
LAV	LAVATORY PUBLIC	6	2	12	1	6	
BT/SH	BATH TUB/SHOWER PUBLIC	6	3	18	3	18	
		18		60		48	
	NEW DOMESTIC WATER SERVICE (DIAMETER ")		1.5	34			
	PIPE PRESSURE DROP (PSVFT SMOOTH PIPE)		1.5	GPM			
	PIPE LENGTH (EQ. FT.)		100				
	BACKFLOW PREVENTER PRESSURE DROP (PSI)		5.0				
	HEIGHT OF HIGHEST FIXTURE (FEET)		6				
	SUMMARY OF BUILDING PRESSURE REQUIREMENTS						
	WATER METER LOSS:		5.0	psi			
	STATIC LOSS (HEIGHT X 0.434 PSVFT)		2.6	psi			
	PIPE LOSS (EQUIVALENT LINEAR FEET X PSI/100) =		1.5	psi			
	REQUIRED OUTLET PRESSURE:		25	psi			
	TOTAL PRESSURE REQUIREMENT:		34.1	psi			
	AVAILABLE CITY PRESSURE::		-35	psi			
	EXTRA PRESSURE:		0.9	psi			
	NO BOOSTER PUMP		0	psi			
			0.9	psi			

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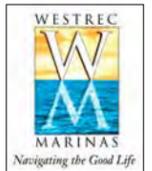
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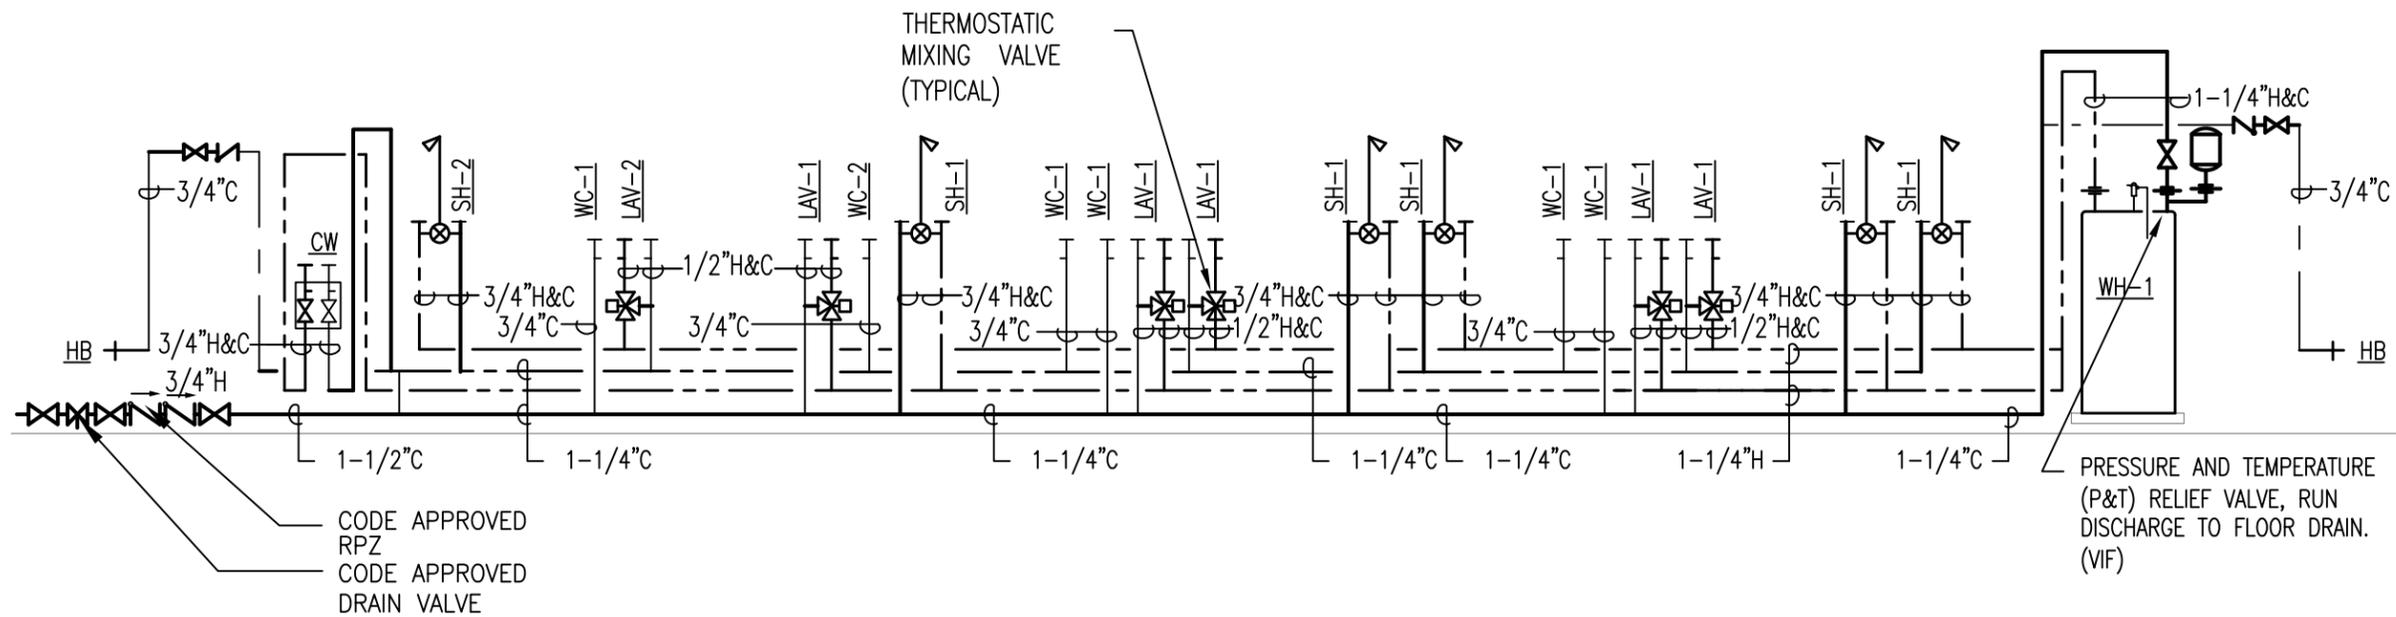
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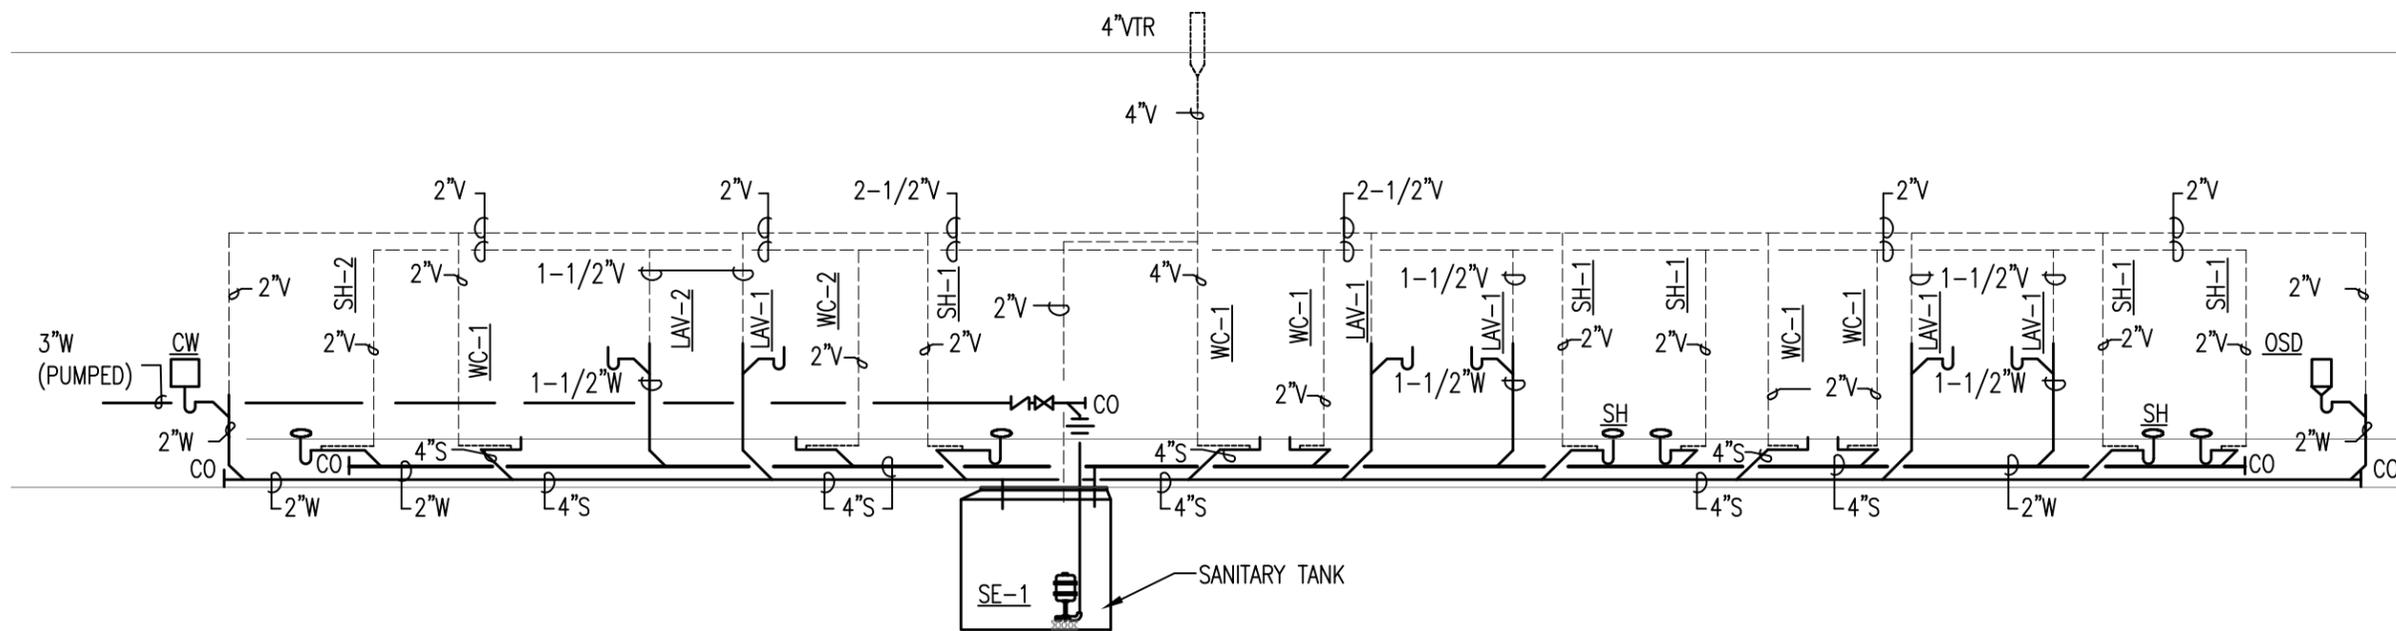
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1 DOMESTIC WATER RISER DIAGRAM
SCALE: N.T.S.



2 SANITARY RISER DIAGRAM
SCALE: N.T.S.

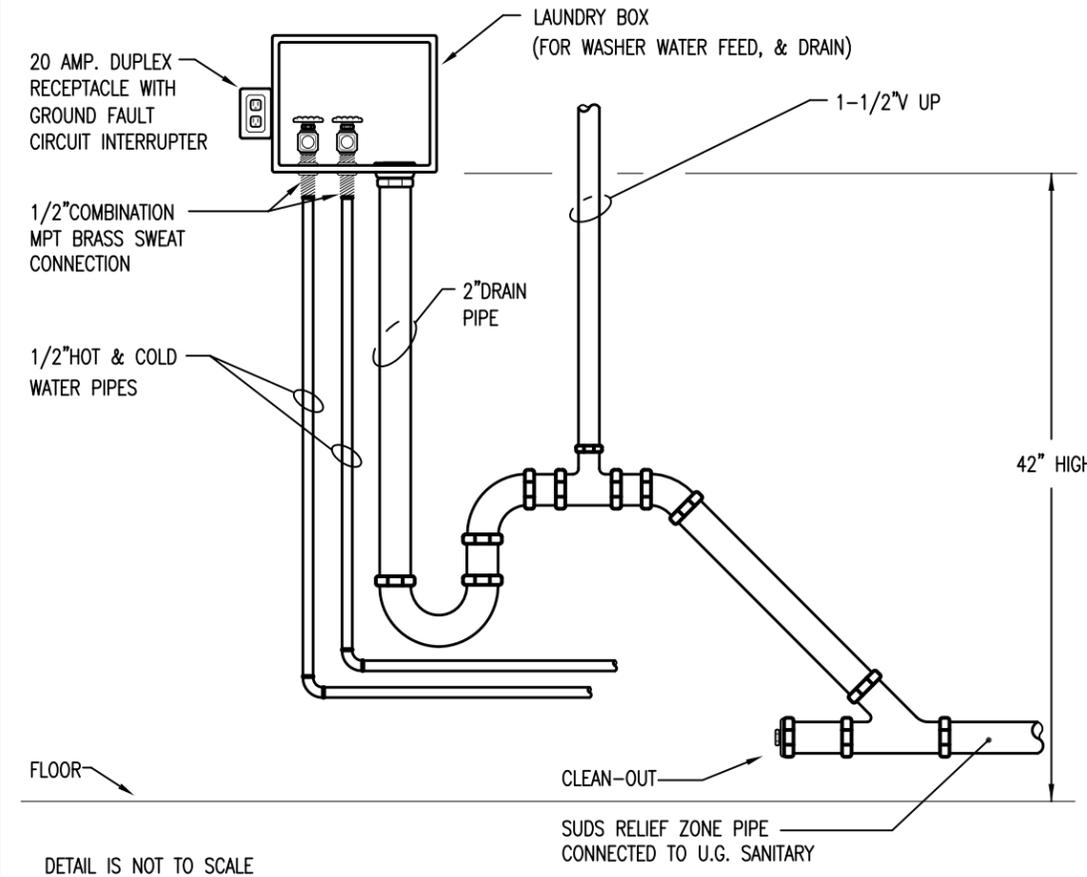
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PLUMBING RISERS

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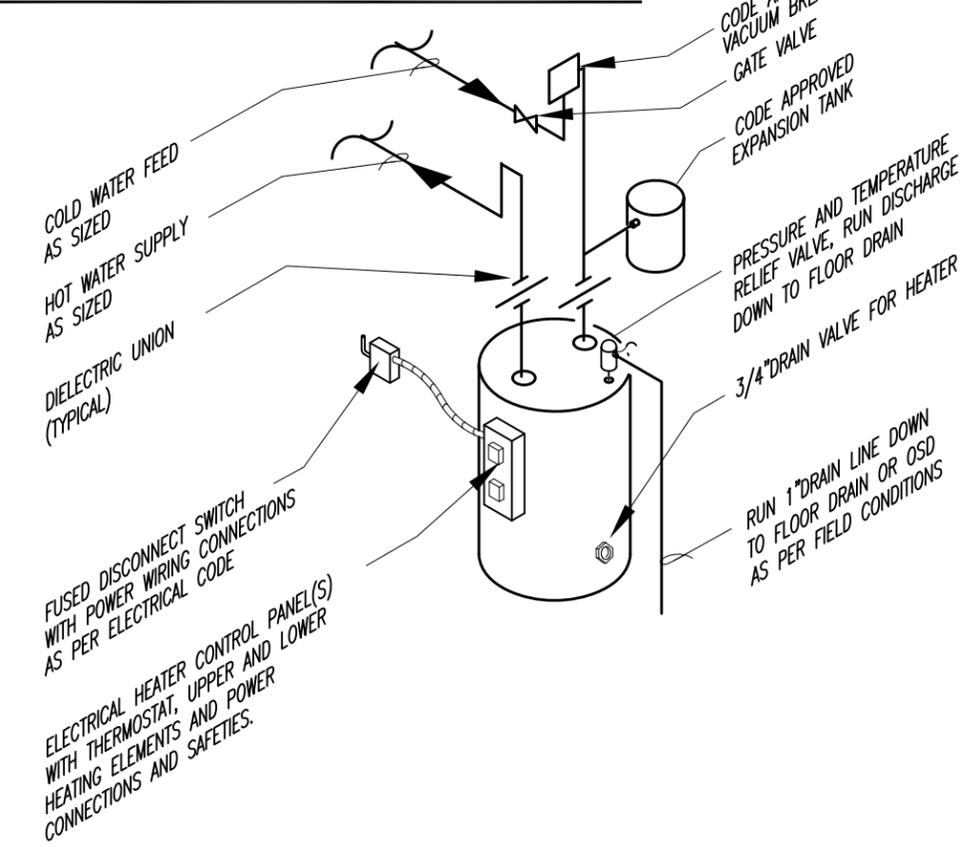
LAUNDRY BOX DETAIL



PLUMBING SYMBOL LIST NOTE THAT ALL SYMBOLS MAY NOT BE USED FOR THIS PROJECT.

PIPE FITTINGS		ABBREVIATIONS	
	GATE VALVE ON VERTICAL PIPE	AD	AREA DRAIN
	STRAINER	AFF	ABOVE FINISHED FLOOR
	DIRECTION OF FLOW	BFP	BACKFLOW PREVENTER
	GATE VALVE	CI	CAST IRON
	CHECK VALVE	CW	CLOTHES WASHING MACHINE
	BALANCING COCK OR, NATURAL GAS COCK	DN	DOWN
	PITCH DOWN IN DIRECTION OF FLOW	DV	DRAIN VALVE
	RISER (ELBOW) DOWN	DS	DOWN SPOUT
	CAPPED PIPE END	DW	DISH WASHING MACHINE
	RISER (TEE) DOWN	DWP	DOMESTIC WATER PUMP
	RISER (ELBOW) UP	EX	EXISTING
	RISER (TEE) UP	FBO	FURNISHED BY OTHERS
	UNION (FLANGED)	FD	FLOOR DRAIN
	UNION	FS	FLOOR SINK
	VENT PIPING	GC	GENERAL CONTRACTOR
	SD STORM DRAIN, SUSPENDED, DOWNSPOUT (DS)	GPM	GALLONS PER MINUTE
	SANITARY (SOIL) OR WASTE SEWER (S,W)	GT	GREASE TRAP
	FOOTING OR SUB-SOIL DRAIN TILE	HB	HOSE BIBB
	DOMESTIC COLD WATER (CW OR C)	HD	HUB OR FUNNEL DRAIN
	DOMESTIC HOT WATER SUPPLY (HW OR H) (WITH TEMPERATURE IF NOT 140F)	INV ELEV	INVERT ELEVATION
	CO CLEAN OUT (CO) PLUG	KS	KITCHEN STACK
	YCO YARD CLEAN OUT	KW	KITCHEN WASTE
	FCO FLOOR CLEAN OUT	LAV	LAVATORY
	WCO WALL CLEAN OUT (WCO)	MB	MOP BASIN
	G NATURAL GAS-LOW PRESSURE	NFSC	NON-FREEZE SILL COCK
	PIPE GUIDE OR SLEEVE	NIC	NOT IN CONTRACT
	MAN HOLE (MH)	OSD	OPEN SITE DRAIN
	CATCH BASIN (CB)	PS	PLUMBING STACK
	STORM CATCH BASIN (SCB)	RD	ROOF DRAIN
	FLOOR DRAIN	ROB	ROD OUT BASIN
	OPEN SITE DRAIN	SK	SINK
		SS	SERVICE SINK OR, STAINLESS STEEL
		SE	SEWAGE EJECTOR
		SP	SUMP PUMP
		TYP	TYPICAL
		U.G.	UNDER GROUND
		UR	URINAL
		VIF	VERIFY IN FIELD
		VTR	VENT THRU ROOF
		WS	WASTE STACK
		WC	WATER CLOSET (TOILET)
		YCO	YARD CLEAN OUT

ELECTRIC WATER HEATER DETAIL

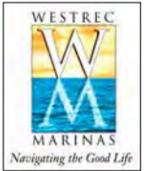


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